
BIKE STORAGE ROOM 120 BIKE SPACES ADDITIONAL BIKE PARKING 8 BIKE SPACES EXTERIOR UNDER CANOPY AND 3 INSIDE 131 BIKE SPACES PROVIDED


BICYCLE PARKING (COMMERCIAL BUILDING)

REQUIRED: 1 SPACE PROVIDED: 1 SPACE UNDER EXTERIOR CANOPY

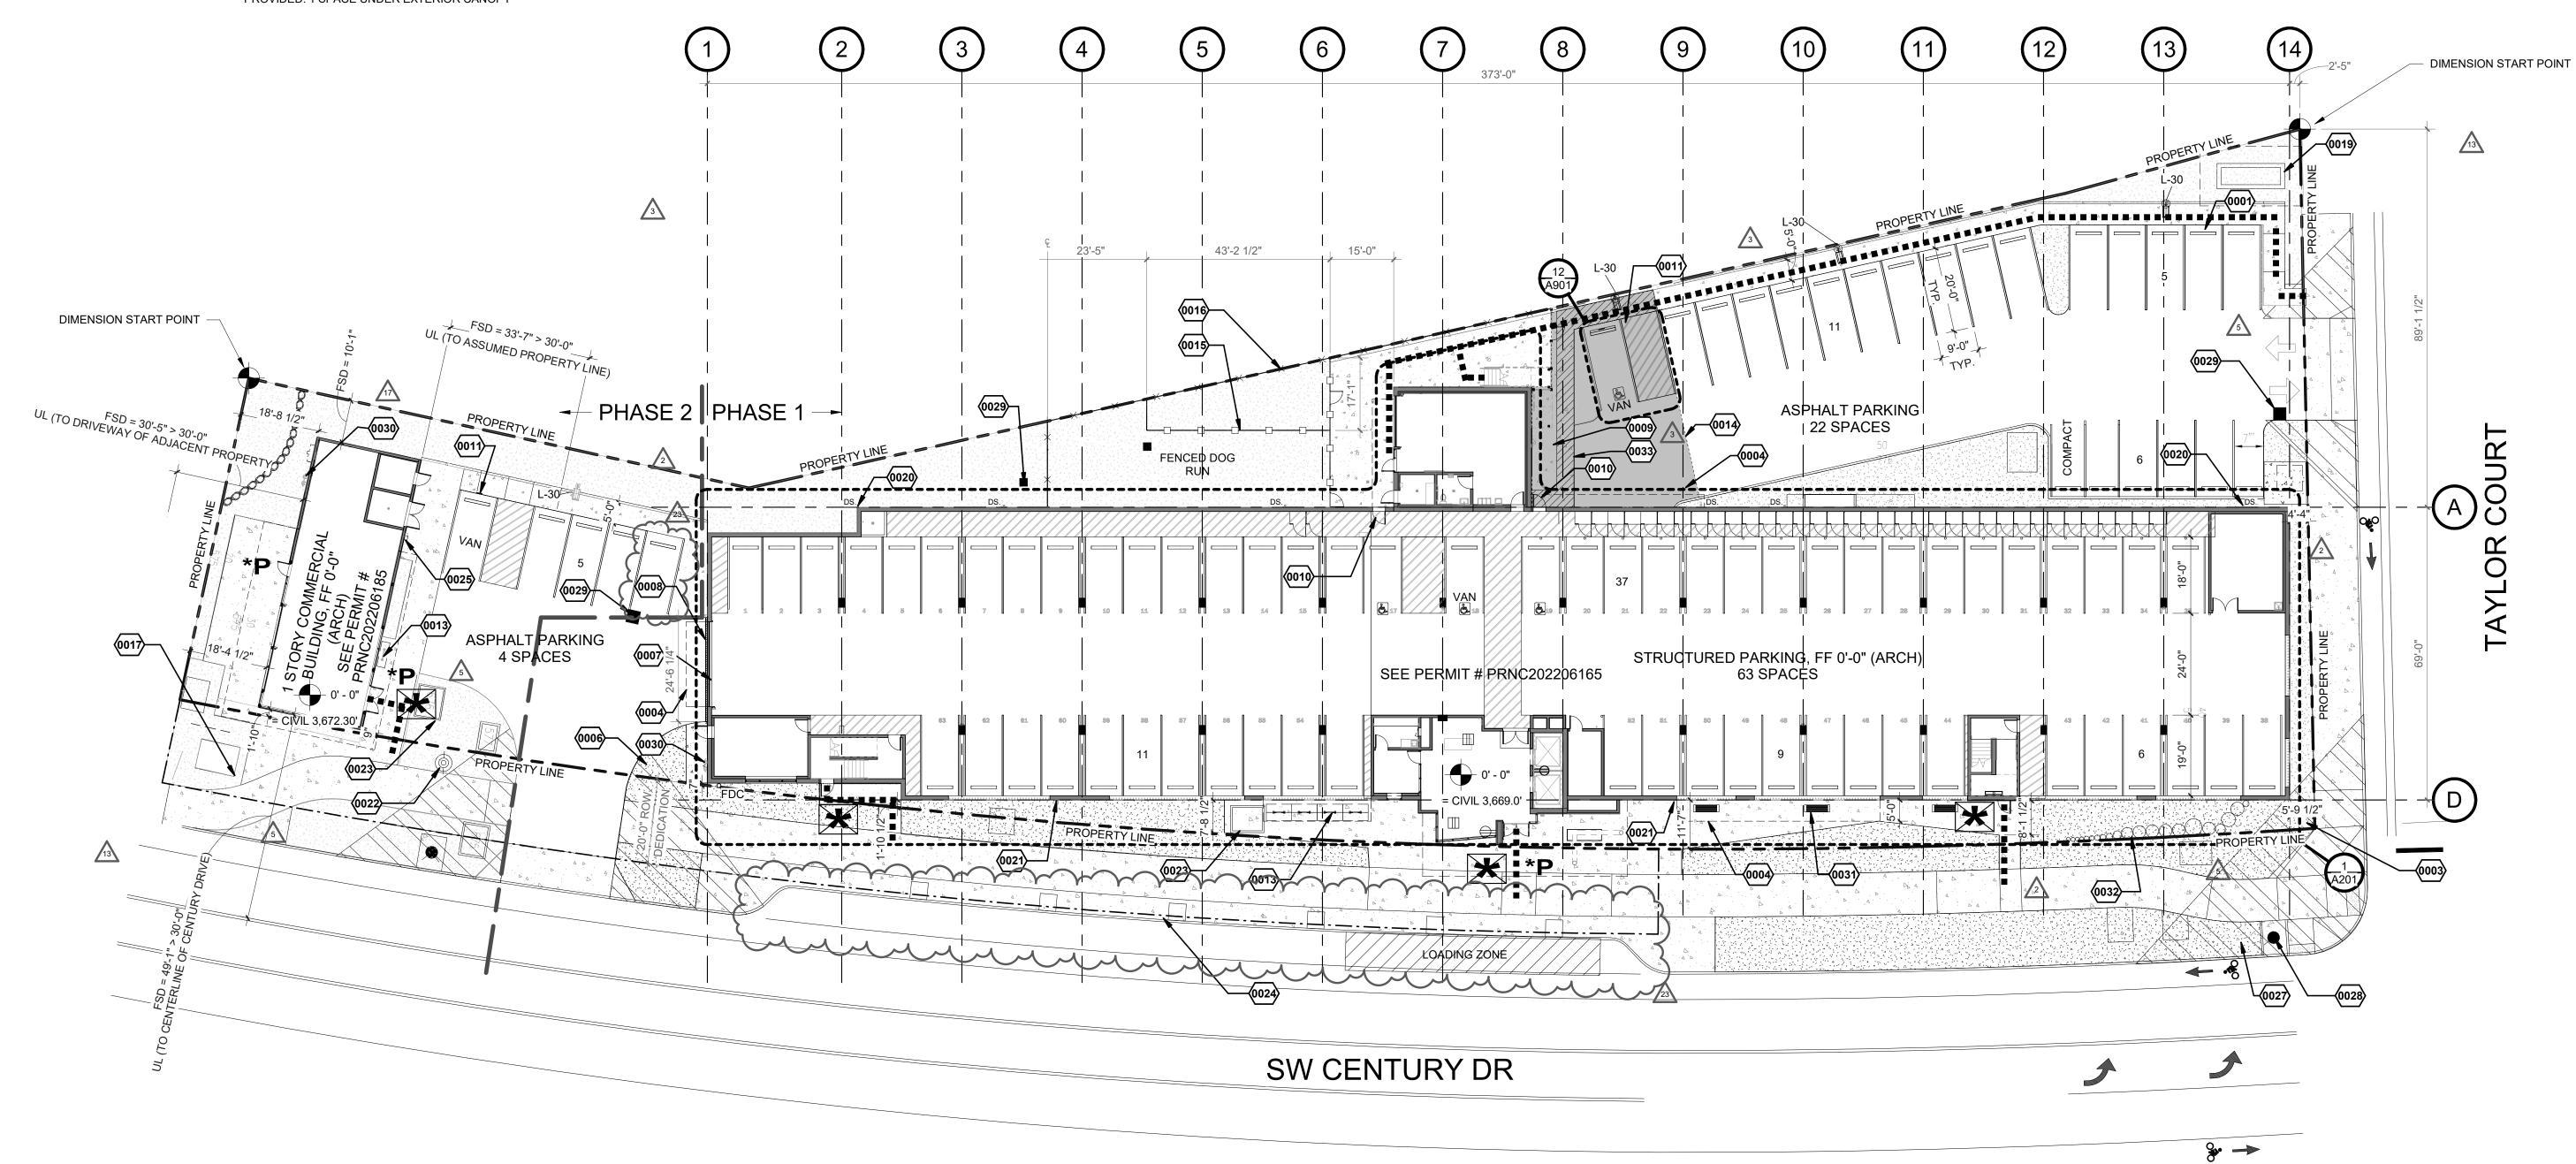

1. OVERALL SITE PLAN

A001 SCALE: 1" = 20'-0"

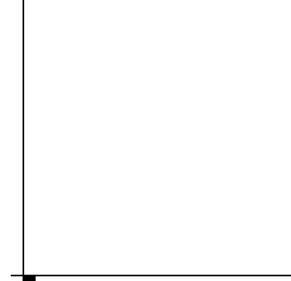

CITY OF BEND

GENERAL NOTES

- A. SITE INFORMATION IS BASED ON OWNERS SURVEY DATED JUNE 9TH, 2021 BY HICKMAN, WILLIAMS &
- ASSOCIATES. B. ALL SURVEY INFORMATION INDICATING ALL EXISTING CONDITIONS ARE SHOWN FOR REFERENCE ONLY. C. ALL PARKING SPACE DIMENSIONS ARE TO ASPHALT
- SIDE OF CURB. PARKING SPACES ARE 9'-0" OC UNO. D. STREET, PARKING, DRIVE CUTS, AND/ OR PUBLIC RIGHT OF WAY INFORMATION ARE SHOWN FOR REFERENCE ONLY. SEE CIVIL DRAWINGS FOR
- DETAILED INFORMATION. E. DIMENSIONS SHOWN ON THIS PLAN ARE FOR GENERAL LAYOUT OF THE BUILDINGS AND SITE
- ELEMENTS. F. REFER TO THE LEGAL SURVEY (PROVIDED BY OTHERS) FOR PROPERTY LINE DIMENSIONS AND
- EXACT LOCATIONS OF EXISTING SITE ELEMENTS. G. SEE CIVIL FOR TYPICAL DIMENSIONS UNO. H. TYPICAL CURB RADIUS IS 3'-0" AT ASPHALT SIDE OF CURB UNO.
- I. SEE SHEET A100OR FOR FIRE SEPERATION DISTANCES J. SEE CIVIL GRADING PLAN K. SIDEWALKS TO HAVE 2% MAX CROSS SLOPE AND 5%

MAX SLOPE IN DIRECTION OF TRAVEL L. SEE ELECTRICAL SITE PLAN **KEYNOTES**

0001 WHEEL STOP, TYP 0003 SEE CIVIL DRAWINGS AND TRAFFIC FACILITIES REPORT FOR MODIFICATION REQUEST TO MEET CITY OF BEND CORNER CLEARANCE REQUIREMENTS DASHED LINES INDICATE CANOPIES

ABOVE WITH SURFACE MOUNTED LIGHT FIXTURES VISION CLEARANCE TRIANGLE, TYP. 0006 OVERHEAD SECTIONAL GARAGE DOOR 0007 8000 TRENCH DRAIN, PER CIVIL 0009 CONCRETE STAGING PAD DOOR INTO GARAGE ON LEVEL 2

0011 ADA SIGN AND POST 0013 BIKE RACKS PER COB DEVELOPMENT CODE SECTION 3.3.600 CONCRETE PAVING WITH SNOW MELT (HYDRONIC LOOP) COORD. W/ PLUMBING 4'-0" CHAIN LINK FENCE; BLACK VINYL 6'-0" CHAIN LINK FENCE; BLACK VINYL ELECTRIC TRANSFORMER PER ELECTRICAL, PROVIDE CONCRETE PAD 0017

EMERGENCY GENERATOR PER ELECTRICAL, PROVIDE CONCRETE PAD PRE-FINISHED GUTTER & DOWNSPOUT, ROOF DRAIN OVERFLOW, TYP. SEE EXTERIOR ELEVATIONS FOR TOTAL

NUMBER AND LOCATION GUY POLE COORDINATE WITH PUBLIC UTILITY COMPANY UTILITY VAULTS COORDINATE WITH CIVIL AND MEP DRAWINGS

TREE GRATE TYP. COORDINATE WITH LANDSCAPE DRAWINGS WALL MOUNTED MAILBOX STREET LIGHT, SEE CIVIL DRAWINGS 0028 FIRE HYDRANT, SEE CIVIL DRAWINGS 0029

0030 GAS METERS COORDINATE WITH UTILITY CUSTOM WOOD BENCH 0032 ROCKERY WALL, SEE LANDSCAPE

ACCESSIBLE ROUTE

AREA DRAIN, SEE CIVIL DRAWINGS

RAMPED TRANSITION CURB, WITH PAVEMENT MARKING DELINEATING THE

LEGEND

EXISTING PROPERTY BOUNDARY SITE PROPERTY BOUNDARY SITE PHASING LINE

PROPOSED LANDSCAPING

OOO SITE EGRESS PATH TO RIGHT OF WAY ENTRY/EXIT ACCESS TO ACCESSIBLE MEANS OF EGRESS

PROPOSED CONCRETE SIDEWALK

*P PUBLIC ENTRY ON ACCESSIBLE ROUTE SITE POLE LIGHTING

NO. OF PARKING SPACES IN GROUP

FIRE HYDRANT O_{FDC} FIRE DEPARTMENT CONNECTION

0' - 0" SPOT GRADE ELEVATION F.F. 123' FINISH FLOOR ELEVATION

ACCESSIBLE EXIT DISCHARGE ACCESS TO PUBLIC RIGHT OF WAY

4'-0" CHAIN LINK FENCE; BLACK VINYL

6'-0" CHAIN LINK FENCE; BLACK VINYL






CONSULTANT:

PROJECT NUMBER: 515 Century Drive - APT BLDG

SW CENTURY DR. BEND, OR 97702

SHEET TITLE: ARCHITECTURAL

SITE PLAN

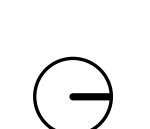

TRUE NORTH

DRAWN BY: 1 CD CHANGES ADDENDUM 1 PLAN CHECK COMM 01 2/14/23 5 PLN CHK ENGG 01 6 PLAN CHECK APT 01 13 CD CHANGES 6/9/23 8/22/23

17 PR 07 23 PR 11 TBD

