

**PROJECT:**  
**RENOVATIONS TO AN EXISTING BUILDING FOR:**  
**RENT ONE**  
**MT. VERNON, ILLINOIS**

**ARCHITECT :**



**Round Table Design** INC.  
 ARCHITECTURE - STRUCTURAL AND PROFESSIONAL ENGINEERING - LAND SURVEYING  
 1020 MAIN STREET MT.VERNON ILLINOIS (618) 244-7819

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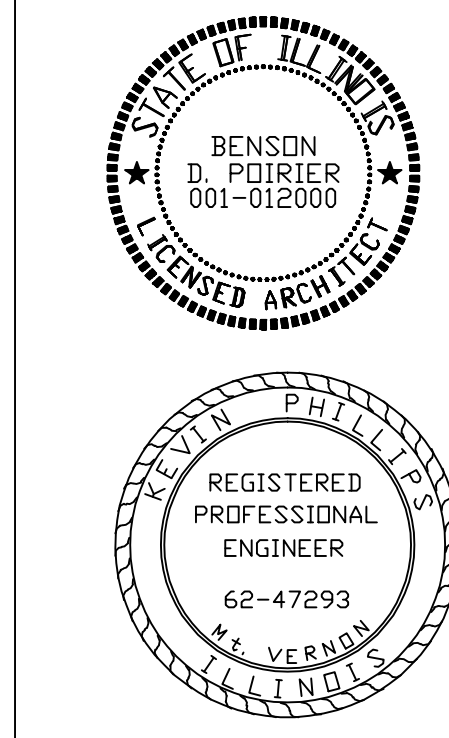
**DESIGN STANDARDS:**  
**INTERNATIONAL BUILDING CODE - 2006**  
**ILLINOIS STATE PLUMBING CODE - 2006**  
**INTERNATIONAL MECHANICAL CODE - 2006**  
**NATIONAL ELECTRIC CODE - 2006**  
**NFPA LIFE SAFETY CODE - 2000**  
**ILLINOIS ACCESSIBILITY CODE - LATEST EDITION**

I, THE UNDERSIGNED, HAVE PREPARED OR CAUSED TO HAVE PREPARED THE FOLLOWING SHEETS (SHEETS A-1 AND A-2) UNDER MY DIRECT SUPERVISION, AND TO THE BEST OF MY KNOWLEDGE COMPLY WITH ALL APPLICABLE CODES.

SIGNED, BENSON D. POIRIER  
 LICENSE EXP. DATE: 11/30/2010

I, THE UNDERSIGNED, HAVE PREPARED OR CAUSED TO HAVE PREPARED THE FOLLOWING SHEETS (SHEETS M-1 THRU P-1) UNDER MY DIRECT SUPERVISION, AND TO THE BEST OF MY KNOWLEDGE COMPLY WITH ALL APPLICABLE CODES.

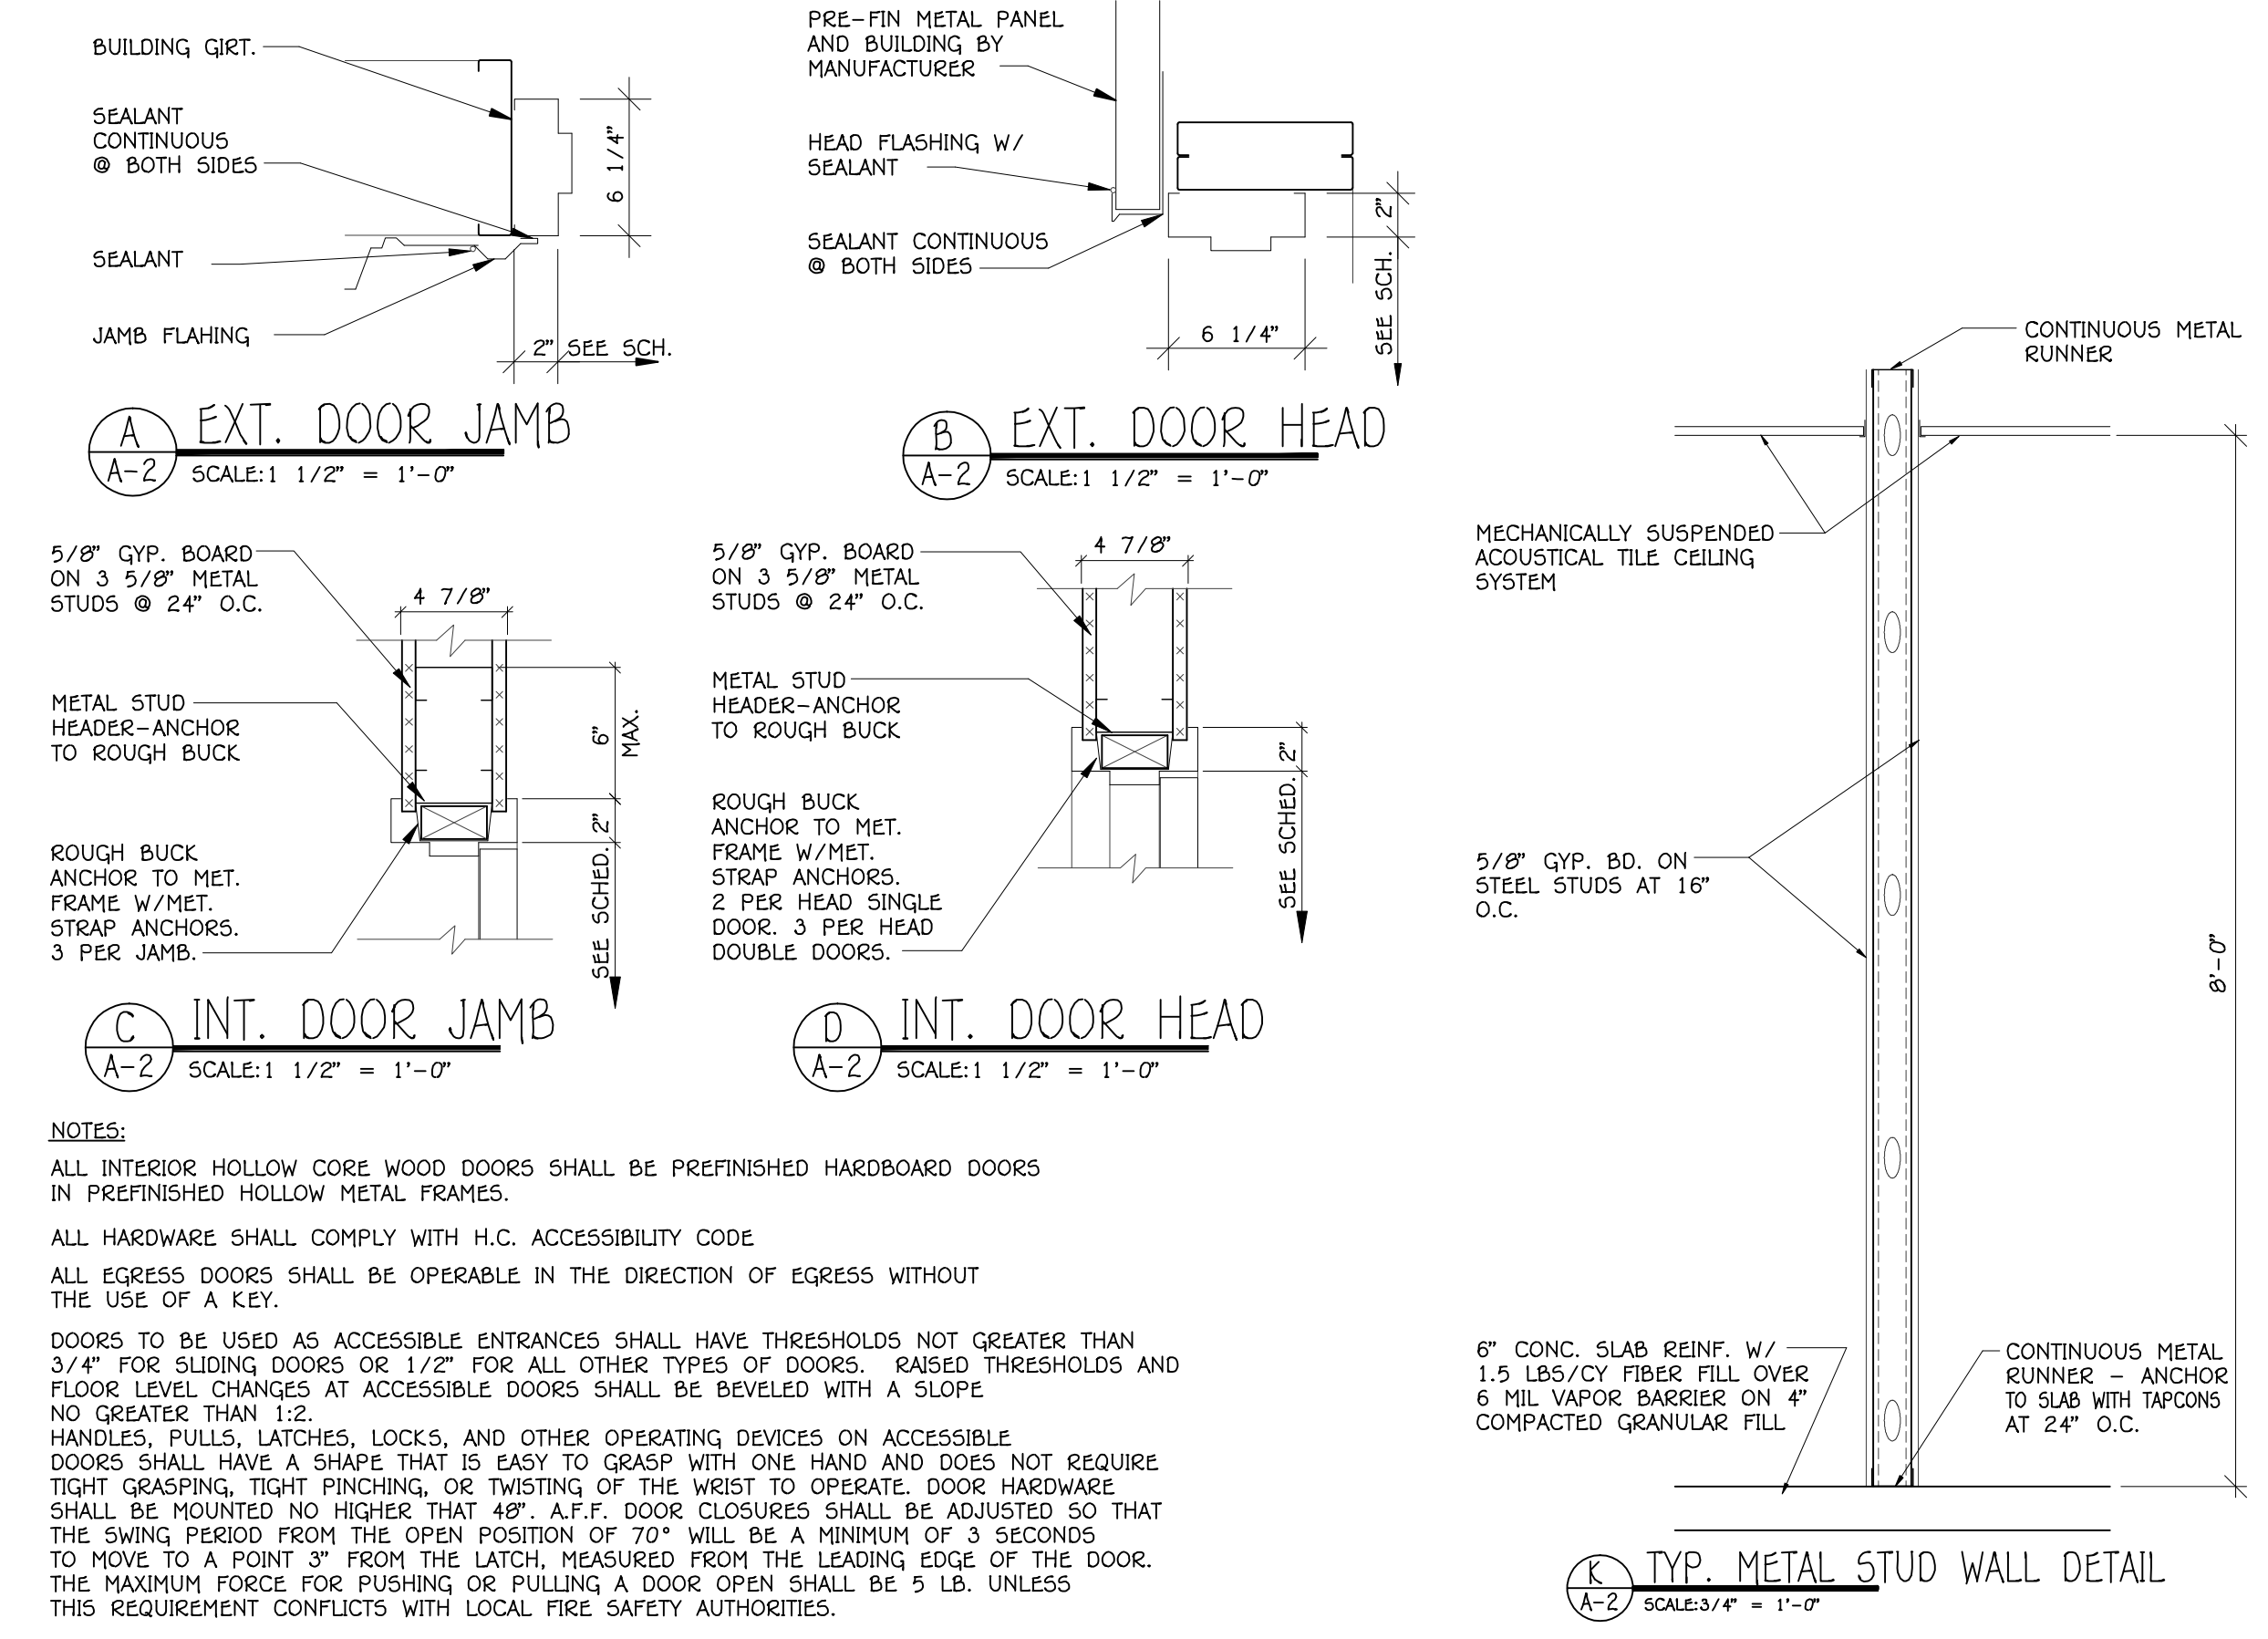
SIGNED, KEVIN PHILLIPS  
 LICENSE EXP. DATE: 11/30/2009



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**A**  
**A-1** **OVERALL FLOOR PLAN**  
 SCALE: 1/16" = 1'-0"  
 NORTH



**NOTES:**  
 ALL INTERIOR HOLLOW CORE WOOD DOORS SHALL BE PREFINISHED HARDBOARD DOORS IN PREFINISHED HOLLOW METAL FRAMES.  
 ALL HARDWARE SHALL COMPLY WITH H.C. ACCESSIBILITY CODE  
 ALL EGRESS DOORS SHALL BE OPERABLE IN THE DIRECTION OF EGRESS WITHOUT THE USE OF A KEY.  
 DOORS TO BE USED AS ACCESSIBLE ENTRANCES SHALL HAVE THRESHOLDS NOT GREATER THAN 3/4" FOR SLIDING DOORS OR 1/2" FOR ALL OTHER TYPES OF DOORS. RAISED THRESHOLDS AND FLOOR LEVEL CHANGES AT ACCESSIBLE DOORS SHALL BE BEVELED WITH A SLOPE NO GREATER THAN 1:2.  
 HANDLES, PULLS, LATCHES, LOCKS, AND OTHER OPERATING DEVICES ON ACCESSIBLE DOORS SHALL HAVE A SHAPE THAT IS EASY TO GRASP WITH ONE HAND AND DOES NOT REQUIRE TIGHT GRASPING, TIGHT PINCHING, OR TWISTING OF THE WRIST TO OPERATE. DOOR HARDWARE SHALL BE MOUNTED NO HIGHER THAN 48" A.F.F. DOOR CLOSURES SHALL BE ADJUSTED SO THAT THE SWING PERIOD FROM THE OPEN POSITION OF 70" WILL BE A MINIMUM OF 3 SECONDS TO MOVE TO A POINT 3" FROM THE LATCH, MEASURED FROM THE LEADING EDGE OF THE DOOR. THE MAXIMUM FORCE FOR PUSHING OR PULLING A DOOR OPEN SHALL BE 5 LB. UNLESS THIS REQUIREMENT CONFLICTS WITH LOCAL FIRE SAFETY AUTHORITIES.  
 PROVIDE CLOSURES ON RESTROOM AND MECHANICAL ROOM DOORS

**RENOVATIONS TO EXISTING BUILDING FOR:**  
**RENT ONE**

**OVERALL BUILDING LAYOUT**

JOB NAME: **RENT ONE**  
 DRAWING TITLE: **OVERALL BUILDING LAYOUT**  
 FILE NAME: 1091680  
 JOB NUMBER: 1091680

DESIGNED BY: **JM**  
 DRAWN BY: **JM**  
 ILLINOIS PROFESSIONAL DESIGNER LICENSE NUMBER: 060201614

DATE: **November 2, 2009**  
 APP. BY: **BOP**

SHEET: **1**