
pbox\01 JAWA STUDIO LAS VEGAS\2016\16057 Heller Companies - Sunset Site\16057 heller companies - sunset business center cd rev2

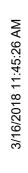






Sunset Business Center





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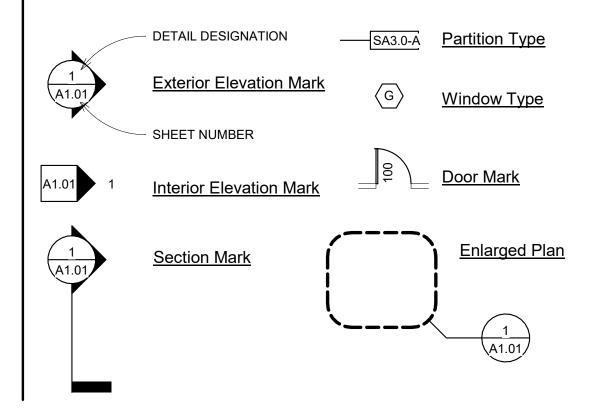




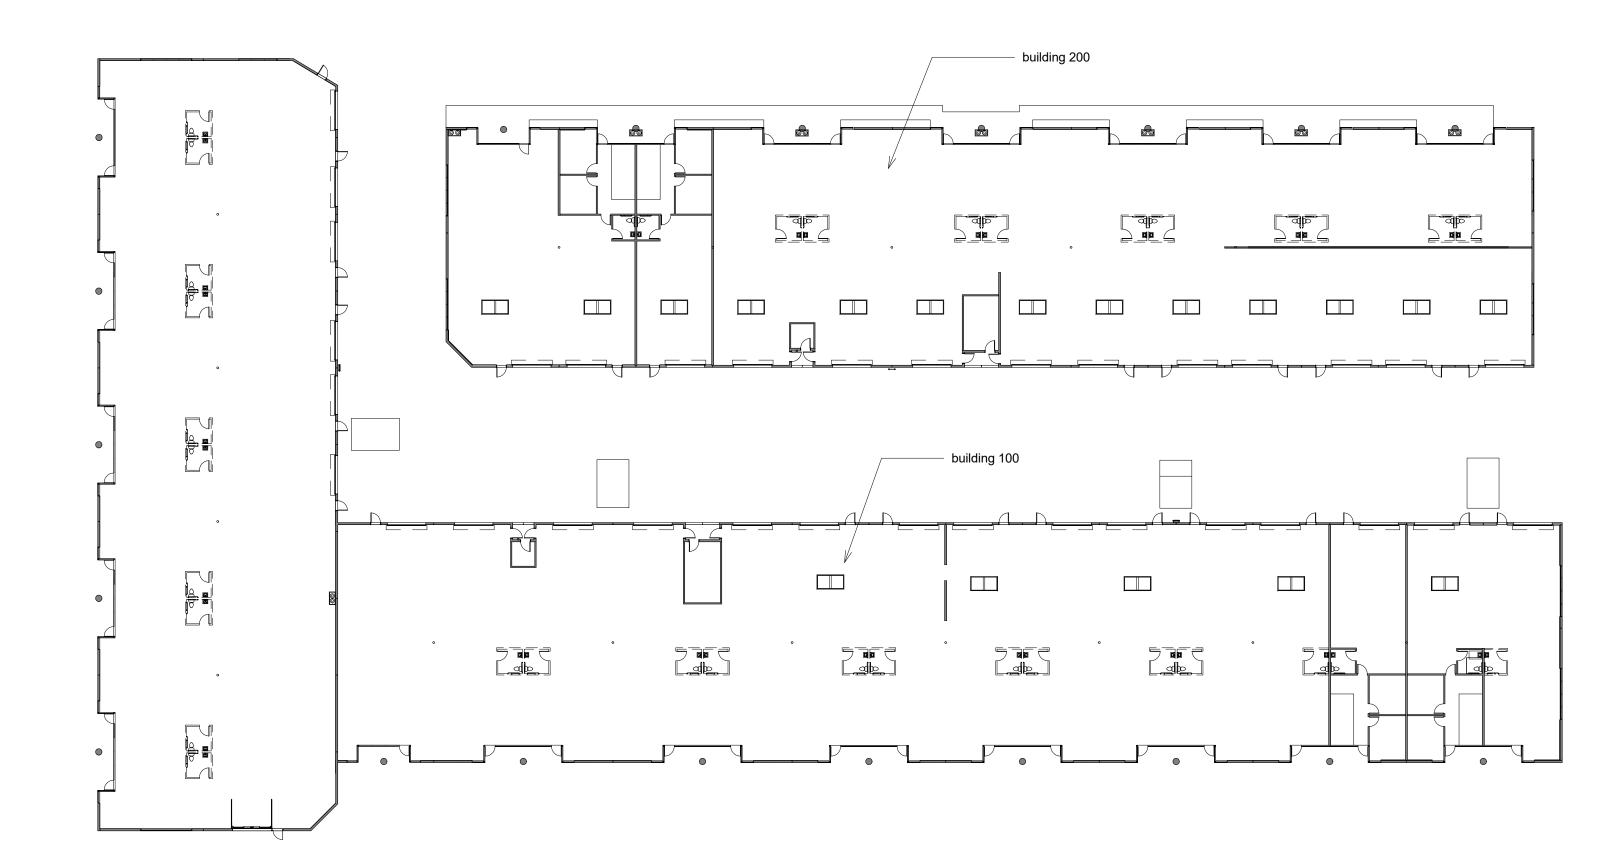

5 Unit- Building 100 - Typical Egress

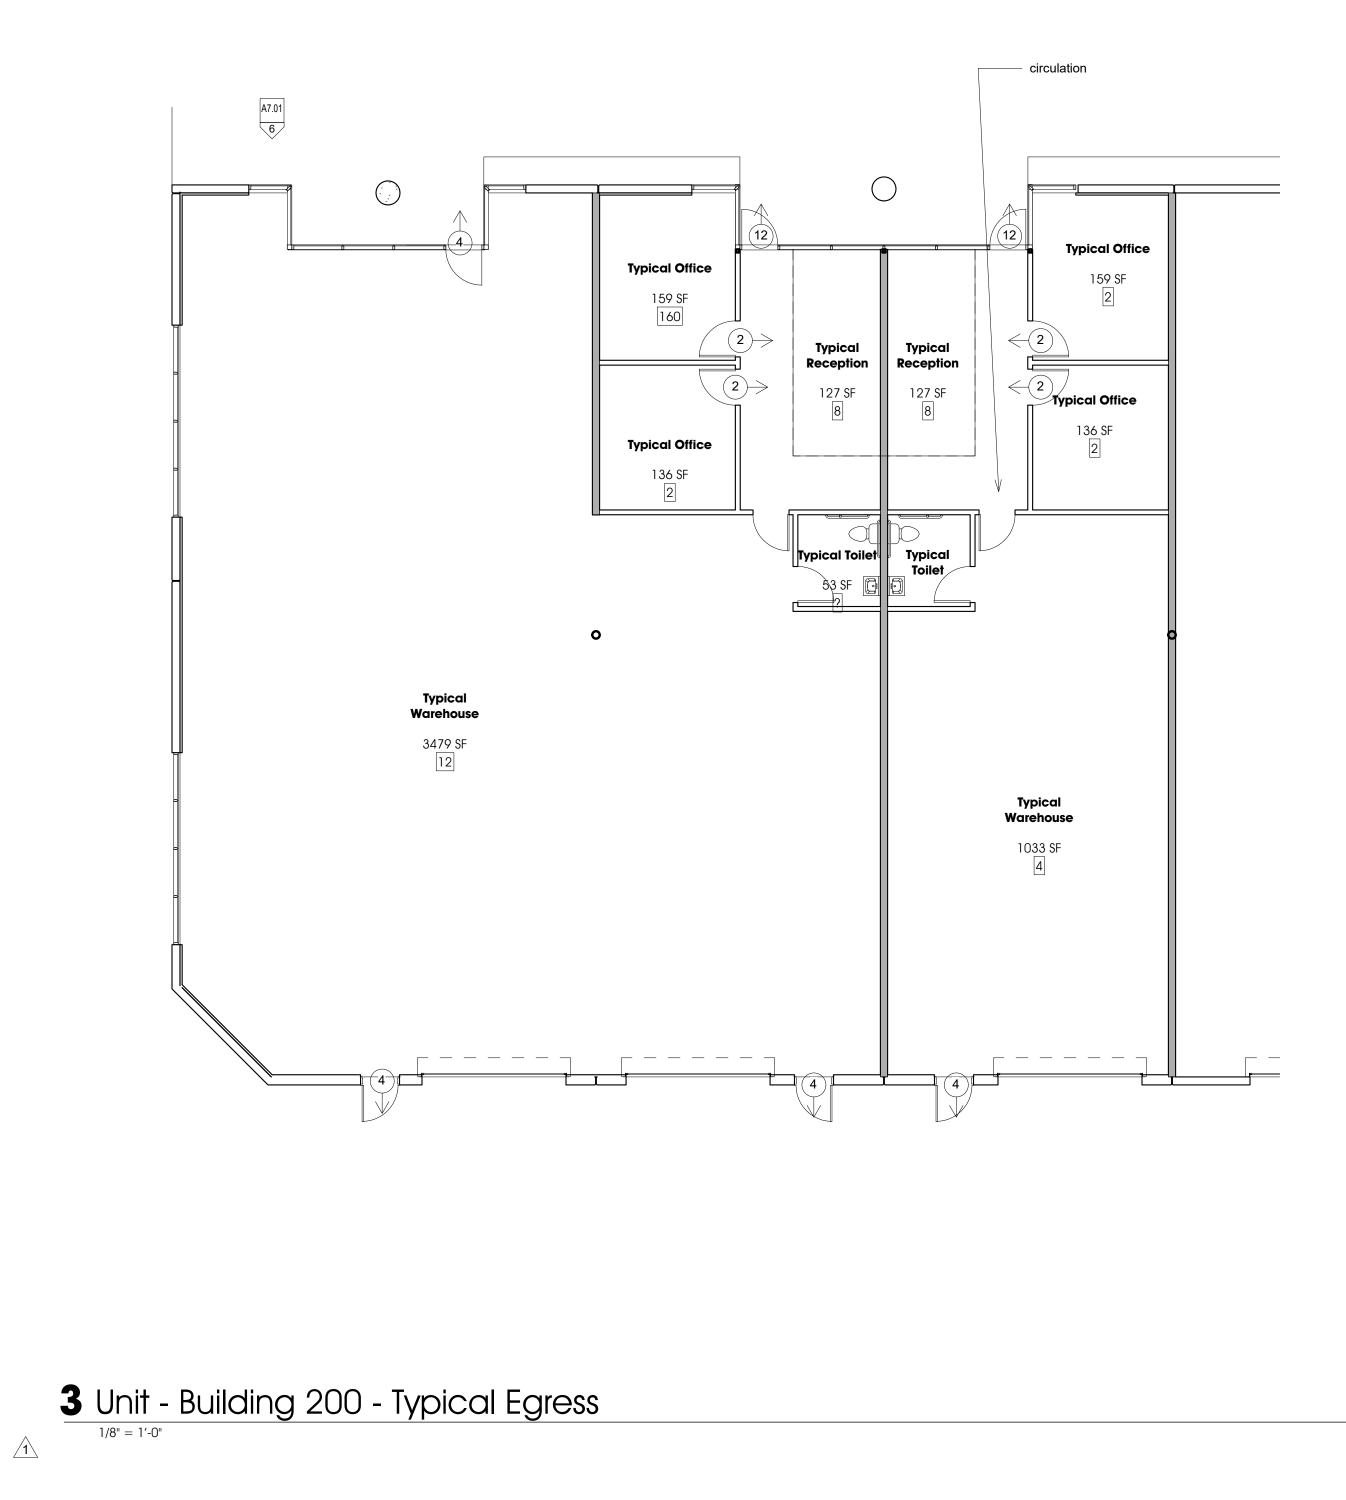
symbols

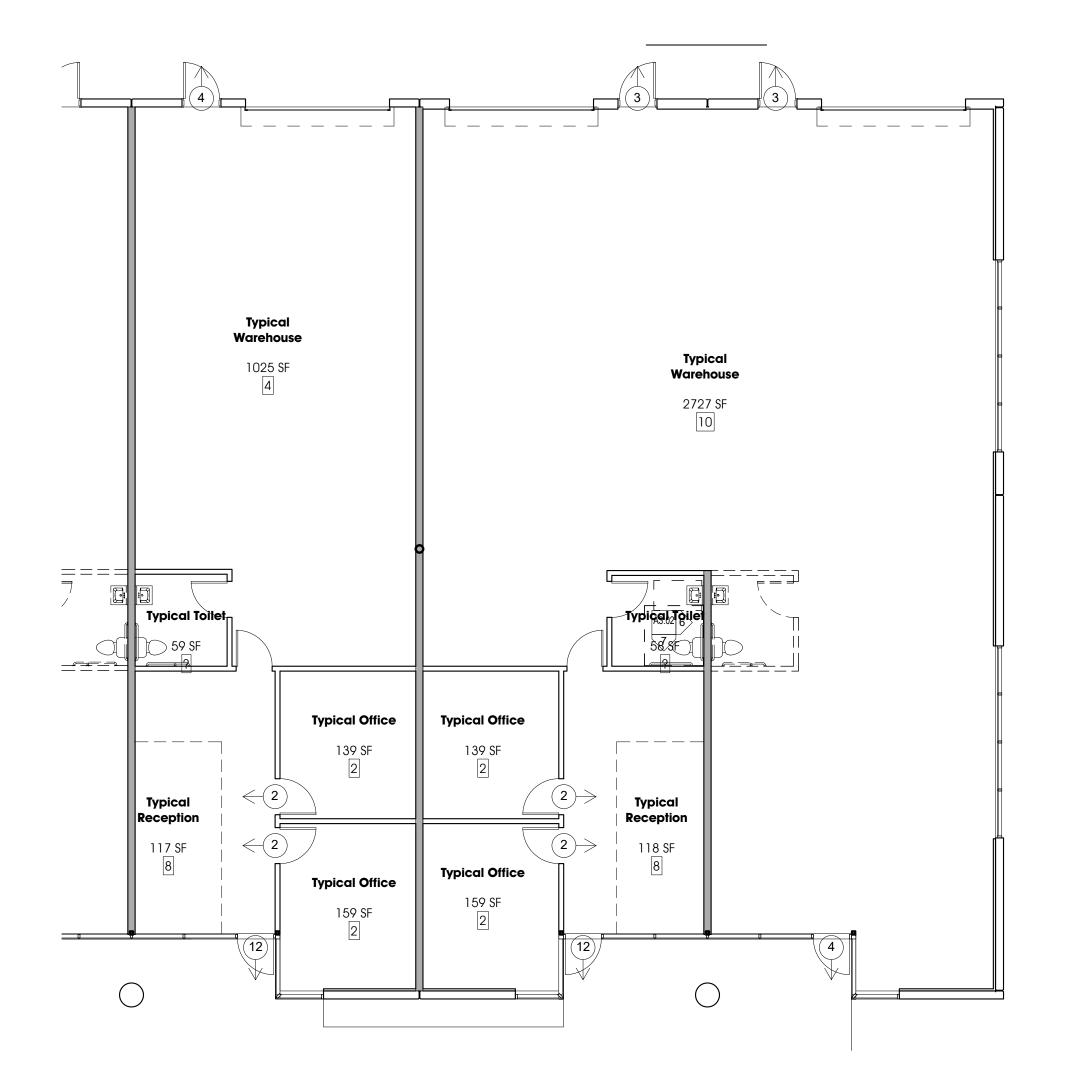

vicinity map



egress notes

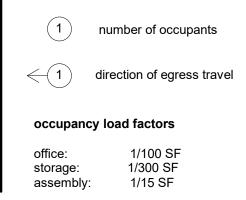

general notes

JEI	
1.	drawings represent the desired result of construction. the method of construction and the risks involved during construction are the responsibility of the contractor. the contractor shall maintain the bldg's structural integrity at all stages of construction
2.	the contractor shall verify all dimensions and elevations prior to commencement of work. discrepancies in dimensions shall be brought to the architects notice for his decision before proceeding with work in the affected area.
3.	contractors shall follow sizes in the construction documents or figures on the drawings in preference to scale measurements. follow detail drawings in preference to general drawings.
4.	where it is obvious that a drawing illustrates only a part of a given work or of a number of items. the remainder shall be deemed repetitive and so constructed.
5.	all the contractors proposed substitutions shall be approved by the architect/engineer prior to commencing any pertinent work.
6.	architectural drawings shall be used in conjunction with mechanical, plumbing, and electrical drawings.
7.	dimensions shown on plans are to the face of the studs or column unless otherwise noted.
8.	any omissions or conflicts between various elements on the plans and or specifications shall be brought to the attention of the architect before proceeding with any of the affected work.
9.	heights and elevations shown on the plans are from the top the finished slab.
10.	contractor responsible for all demolition required to perform work.

abbreviations

A.F.F.	ABOVE FINISHED FLOOR	O.C.	ON CENTER
CLR.	CLEAR	O.H.	OPPOSITE HAND
DEG.	DEGREES	S.F.	SQUARE FEET
DIA.	DIAMETER	SIM.	SIMILAR
EQ.	EQUAL	TYP.	TYPICAL
GA.	GAUGE	_U.O.N	UNLESS OTHERWISE
MIN.	MINIMUM	NOTED	
		V.I.F.	VERIFY IN FIELD
_MAX	MAXIMUM		
_N.I.C	NOT IN CONTRACT		

code analysis

basis of design	Plans shall comply with 2012 IBC, 20 2012 UMC, 2012 UPC, 2012 IECC, 2 uniform administrative code, and 2012		
	amendments		anu 2012
apn	176-02-501-002		
occupancy classification	B (office), S-1 (Storage)		
type of construction	shell: IIIB		
fire sprinklers required: Y	type: NFPA 13		
fire alarm required: N	NA		
limiting occupancy S-1			
height:	allowable:75'	actual:	32'
stories	allowable:3 actual:1		1
area	allowable:70,000	actual:	Bldg 10 Bldg 20
roofing material	allowable: any	actual:	С
occupant load	60% warehouse 40% office		
required plumbing fixtures	plumbing to be stubed in for TI at lat 1 unisex accessible restroom per u		
fire resistance information	occupancy load or b require.	uilding lo	cation do
construction area	69,906 SF		

sheet list

Sheet No.	Sheet Name	Issue D
0.000		12/5/2017
SK-4	Unnamed	02/02/18
A0.00	Information Sheet	12/5/2017
A0.01	Site Plan	12/5/2017
A0.02	IECC Energy Compliance	12/5/2017
A1.01	Building 100 Floor Plan	12/5/2017
A1.02	Building 200 Floor Plan	12/5/2017
A1.03	Building 100 Ceiling Plan	12/5/2017
A1.04	Building 200 Ceiling Plan	12/5/2017
A1.05	Building 100 Roof Plan	12/5/2017
A1.06 A2.01	Building 200 Roof Plan Building 100 Exterior Elevations	12/5/2017 12/5/2017
A2.01 A2.02	Building 200 Exterior Elevations	12/5/2017
A2.02	Building 100 Enlarged Elevations	12/5/2017
A3.01	Enlarged Floor Plans	12/5/2017
A3.02	Enlarged Floor Plans	12/5/2017
A4.01	Typical Details	12/5/2017
A4.02	Typical Details	12/5/2017
A4.03	Details	12/5/2017
A5.01	Building 100 - Sections	12/5/2017
A5.02	Building 100 - Sections	12/5/2017
A5.03	Building 200 - Sections	12/5/2017
A6.01	Building 100 - Wall Sections	12/5/2017
A7.01	Store Fronts	12/5/2017
S0.01	General Structural Notes	08/18/17
S1.01	Foundation Plan- Overall	08/18/17
S1.02	Foundation Plan- Building 100A	08/18/17
S1.03	Foundation Plan- Building 100B	08/18/17
S1.04	Foundation Plan- Building 200	08/18/17
S2.01	Roof Framing Plan-Overall	08/18/17
S2.02 S2.03	Roof Framing Plan-Building 100A	08/18/17
S2.03 S2.04	Roof Framing Plan-Building 100B Roof Framing Plan-Building 200	08/18/17 08/18/17
S3.01	Tilt-Up Elevations	08/18/17
S3.02	Tilt-Up Elevations	08/18/17
S3.03	Tilt-Up Elevations	08/18/17
S3.04	Tilt-Up Elevations	08/18/17
S3.05	Tilt-Up Elevations	08/18/17
S4.01	Typical Tilt Panel Details	08/18/17
S4.02	Typical Concrete Details	08/18/17
S4.03	Typical Steel Details	08/18/17
S5.01	Foundation Details	08/18/17
S6.01	Roof Framing Details	08/18/17
M0.00	Mechanical Symbols, Abbreviations and Drawing Index	08/21/17
M0.01	Mechanical and Plumbing Specifications	08/21/17
M0.02	Mechanical and Plumbing Schedules	08/21/17
M0.03	Mechanical and Plumbing Diagrams	08/21/17
M2.01	Mechanical Plan First Floor Building 100	08/21/17
M2.02	Mechanical Plan First Floor Building 200	08/21/17
P2.01	Plumbing Plan First Flooor Building 100	08/21/17
P2.02	Plumbing Plan First Flooor Building 200	08/21/17
E0.00	Electrical Symbols, Abbreviations and Drawing List	08/21/17
E0.01	Electrical Specifications and Diagrams	08/21/17
E0.02	ECC Compliance Statement and Fixture Schedule	08/21/17
E0.03	Electrical Single Line Diagram and Panel Schedules	08/21/17
E2.01	Lighting Plan Building 100	08/21/17
E2.02	Lighting Plan Building 200	08/21/17
E2.03	Electrical Plan Building 100	08/21/17
E2.04	Electrical Plan Building 200	08/21/17




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AND _____ ERWISE Documents prepared by the architect are instruments of service for use solely with respect to this project. The architect shall retain all common law, statutory and other rights, including copyright. The owner shall not reuse or permit the reuse of the architect's documents except by mutual agreement in writing. © copyright 2017, jawa studio, Itd. 011 NEC, , 2014)12 local _____ _____ _____ _____ _____ 9 100 : 45,229 SF 9 200: 24,677 SF _____ _____ ter date nit min does not Issue Date s Center ad 12/5/2017 02/02/18 12/5/2017 12/5/2017 12/5/2017 set Business (Sunset Roa 12/5/2017 12/5/2017 12/5/2017 12/5/2017 12/5/2017 12/5/2017 12/5/2017 12/5/2017 12/5/2017 12/5/2017 Sunse 12/5/2017 12/5/2017 12/5/2017 12/5/2017 12/5/2017 12/5/2017 12/5/2017 12/5/2017 12/5/2017 lies 08/18/17 08/18/17 08/18/17 08/18/17 08/18/17 08/18/17 08/18/17 08/18/17 \cap 08/18/17 08/18/17 08/18/17 eller 08/18/17 08/18/17 08/18/17 08/18/17 08/18/17 08/18/17 08/18/17 08/18/17 sheet title: 08/21/17 Information Sheet 08/21/17 08/21/17 08/21/17 drawn/checked by: 08/21/17 Author / Checker 08/21/17 date: 08.08.17 08/21/17 08/21/17 job no. 08/21/17 16057 08/21/17 sheet no. 08/21/17 08/21/17

A0.00



parking analysis

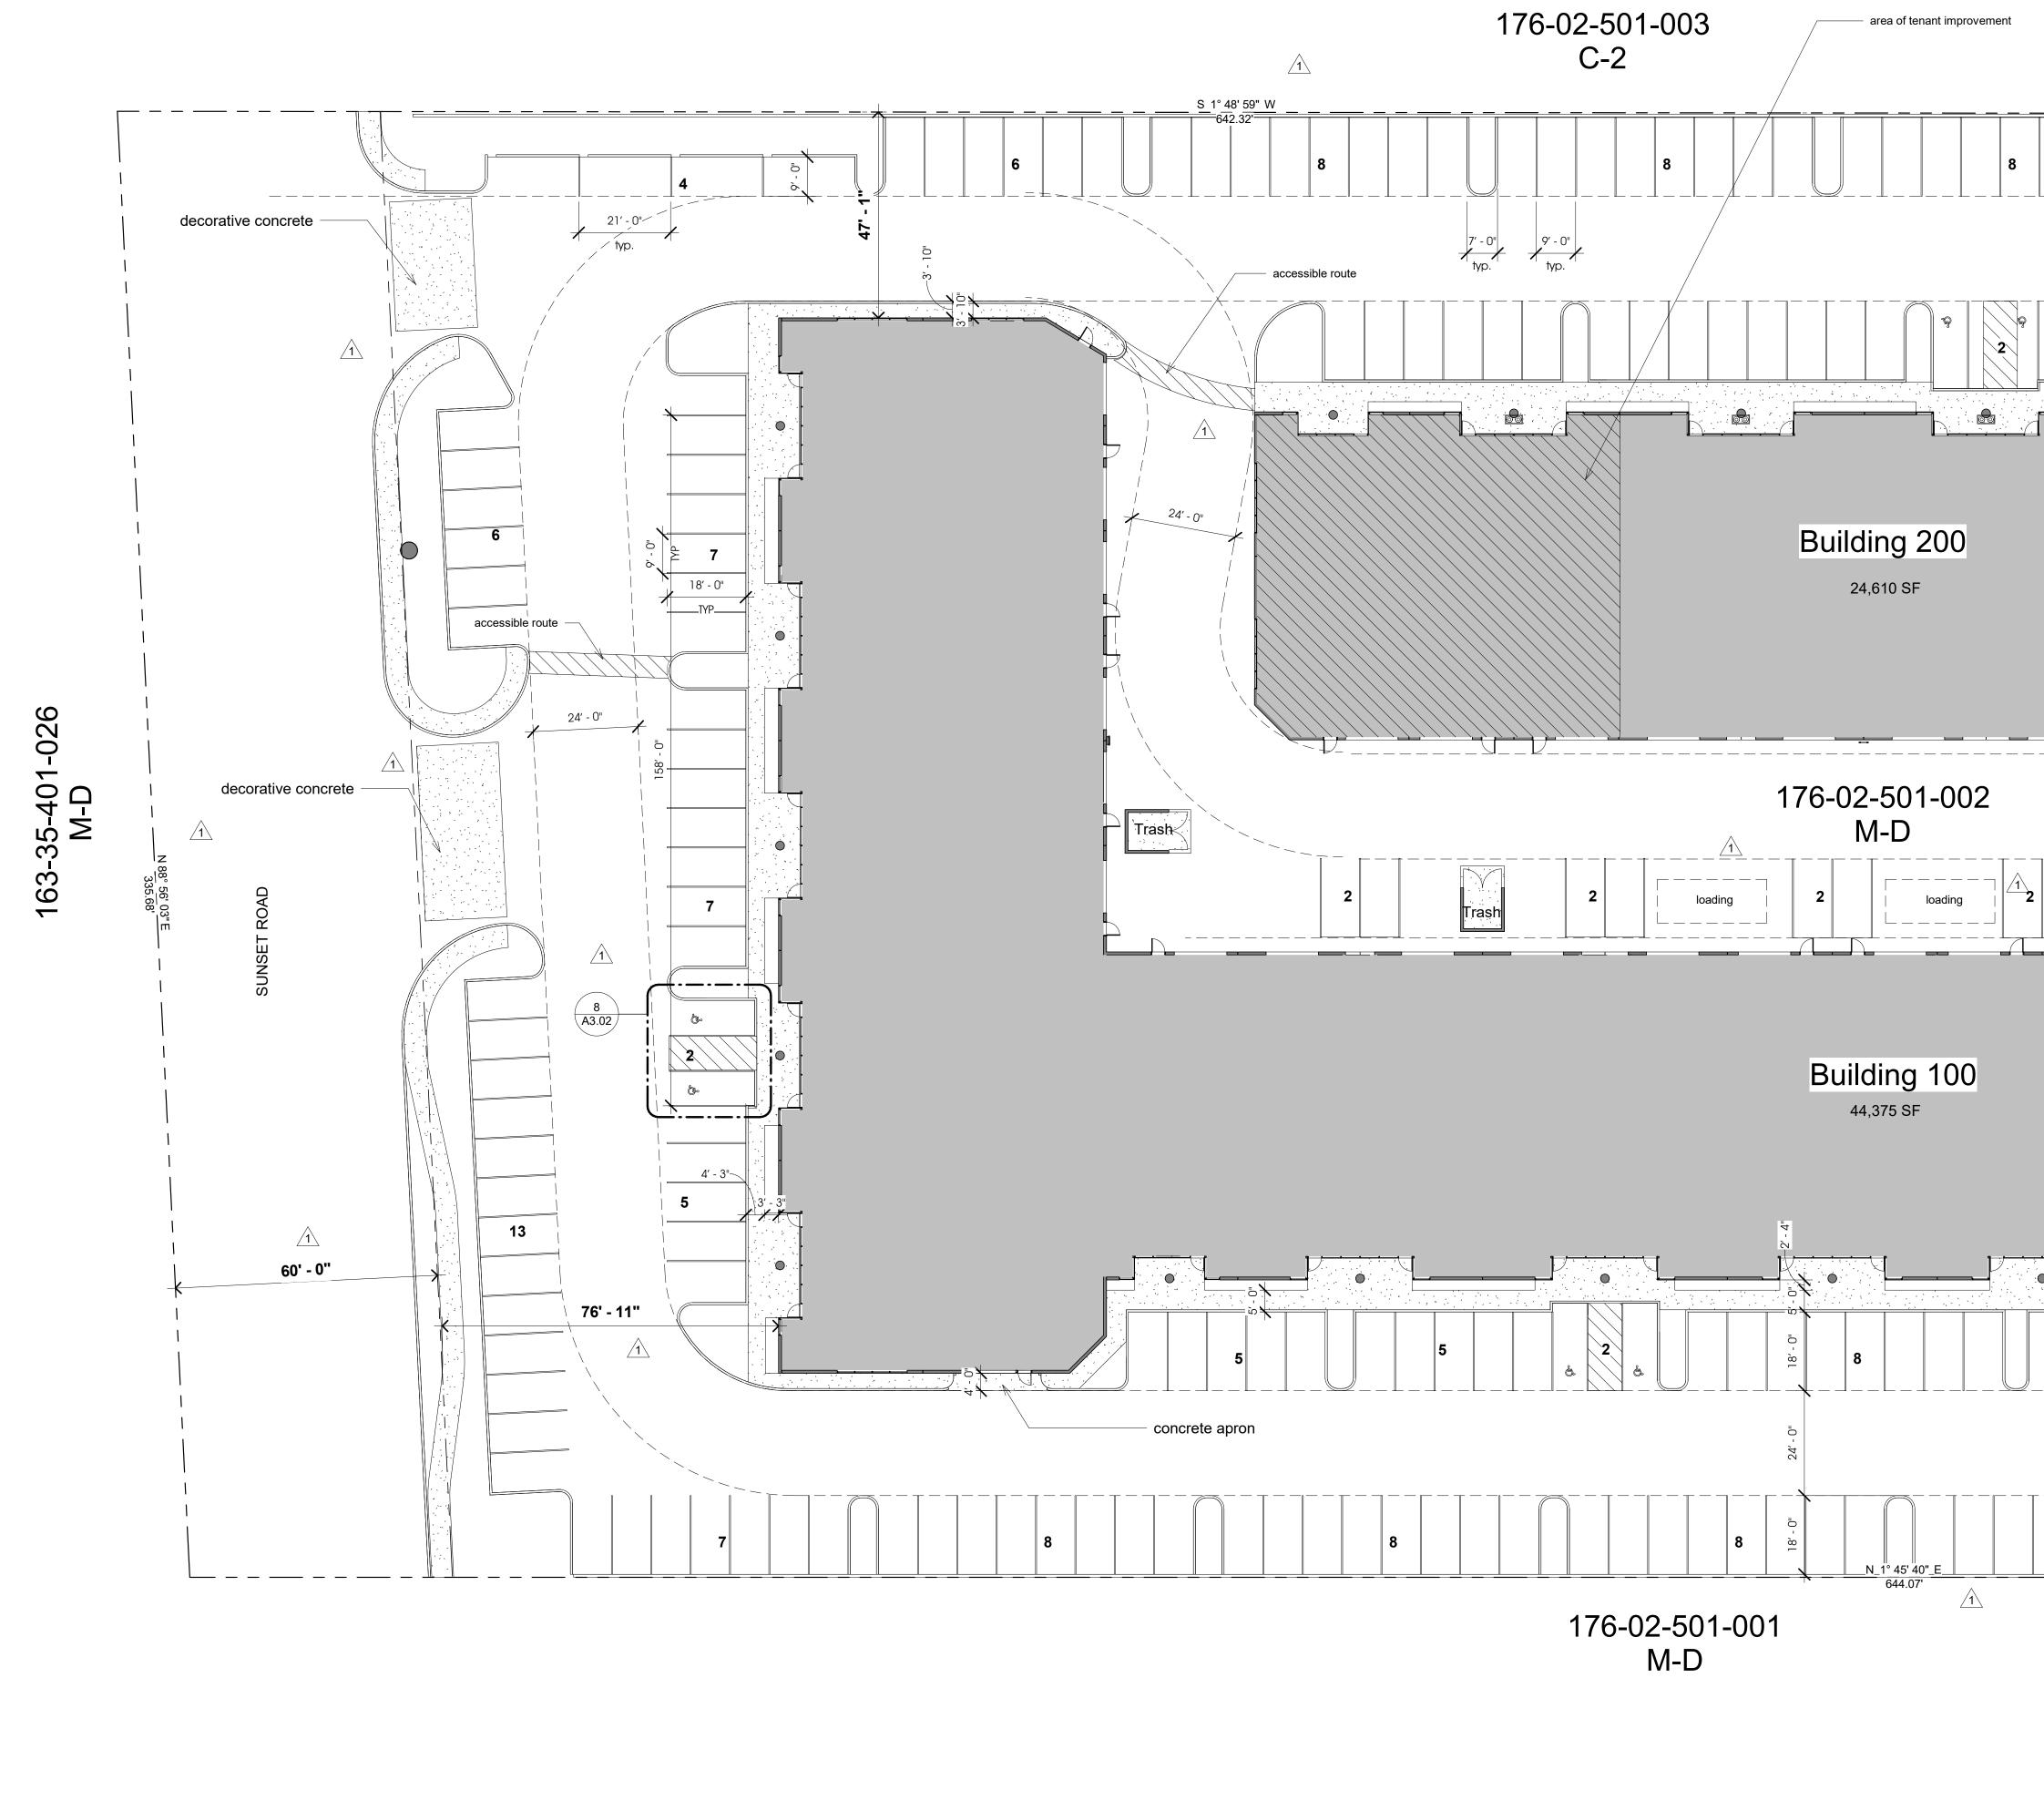Warehouse / Distribution 2 spaces / 1,000 SF

Office 4 spaces / 1,000 SF

Parking Provided = 249 spaces Including 8 accessible spaces


78% office 22% warehouse 69,906 SF

54,526 SF office - 218 spaces for office 15,379 SF warehouse - 31 spaces for warehouse Total 249 spaces required



APN:	176-02-501-002
Zoning:	Current: C-2 Resolution of intenet: N ZC-0165-17
Lot Area:	4.95 acres - gross 4.52 acres - net
Lot Coverage:	69,948 SF / 196,980 Sl 35.5% lot coverage Allowable 80%
Building:	30' Maximum Height

<u>∕1</u>∖ <u>∕1</u>∖ 45' - 11''____ ·. 🛃 🤇 7 18′ - 0" 24′ - 0" -022 176-02-501-M-D _____ -25' - 0" loading Trash rash 43' - 11"_

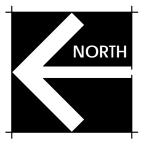

net: M-D


80 SF =



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A0.01

<u>∕1</u>∖ area of tenant improvement

COMcheck Software Version 4.0.7.1 Envelope Compliance Certificate

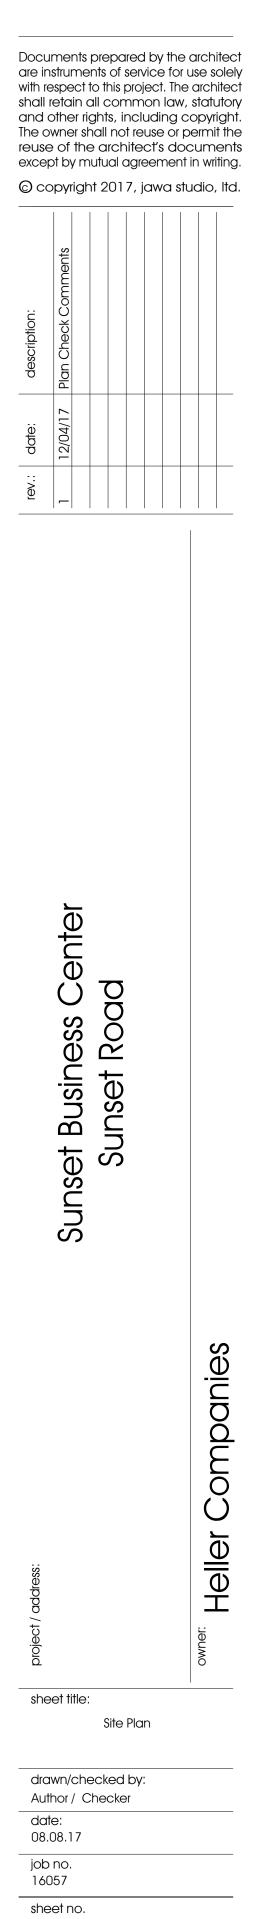Project Information 2012 IECC Energy Code: Sunset Business Center Project Title: Location: Las Vegas, null Climate Zone: 3b Project Type: **New Construction** 25% Vertical Glazing / Wall Area: 17-39710, 17-39715 Permit No. Owner/Agent: Construction Site: Designer/Contractor: Heller Companies 6280 S. Valley View Blvd 6445 West Sunset Rd. JAWA Studios 107 E. Charleston Las Vegas, NV 89118 Suite 106 Suite 250 Las Vegas, NV 89118 702-320-4400 Las Vegas, NV 89104 702-598-1723 dave@hellercompanies robert@jawastudio.com **Building Area** Floor Area 1-Office : Nonresidential 672 Additional Efficiency Package Unspecified Envelope Assemblies Assembly Gross Area Cavity Cont. Proposed Budget Uor R-Value R-Value U-Factor Factor(a) Perimeter Roof 1: Attic Roof with Steel Joists, [Bldg. Use 1 - Office] : Comment: 0.027 632 38.0 0.035 0.0 Exterior Wall 1: Solid Concrete:7" Thickness, Normal Density, Furring: 0.0 0.114 0.110 76 6.2 Metal, [Bldg. Use 1 - Office] Interior Walls: Steel-Framed, 24" o.c., [Bldg. Use 1 - Office] 128 15.0 0.0 0.102 0.064 0.094 0.064 Interior Walls: Steel-Framed, 24" o.c., [Bldg. Use 1 - Office] 19.0 0.0 184 Window 1: Metal Frame with Thermal Break:Fixed, Perf. Specs.: 0.480 0.460 72 ----Product ID COG-0.4400, SHGC 0.62, PF 0.40, [Bldg. Use 1 - Office] : Comment: Tinted Glass (b)

(a) Budget U-factors are used for software baseline calculations ONLY, and are not code requirements. (b) Fenestration product performance must be certified in accordance with NFRC and requires supporting documentation.

Project Title: Sunset Business Center Data filename: E:\LVVWD\Sunset Business Center.cck revised.cck

Door 1: Glass (> 50% glazing):Metal Frame, Entrance Door, Perf.

Office] : Comment: Tinted Glass (b)

Door 2: Wood, Swinging, [Bldg. Use 1 - Office]

Specs.: Product ID COG-0-4400, SHGC 0.62, PF 0.40, [Bldg. Use 1 -

Section # & Req.ID	Mechanical Rough-In Inspection	Complies?	Comments/Assumptions
	Stair and elevator shaft vents have motorized dampers that automatically close.	Complies Does Not Not Observable	Exception: Requirement does not apply.

24

--- ---

21 --- ---


0.480

0.770

0.610 0.610

Report date: 12/04/17

Page 1 of 9

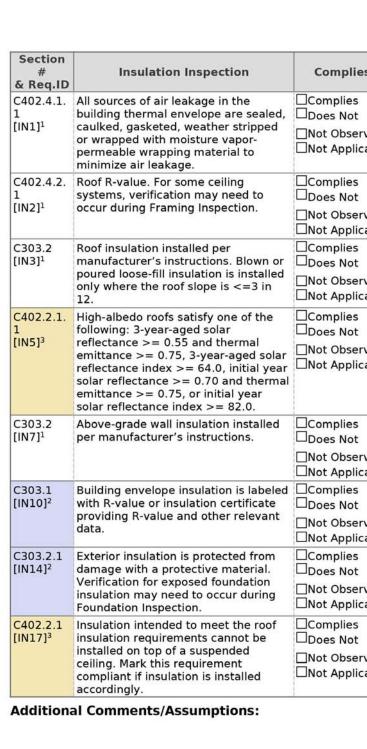

Project Title: Sunset Business Center

Data filename: E:\LVVWD\Sunset Business Center.cck revised.cck

Complies?

Complies

	1 High Impact (Tier 1) 2 Medium Impact (Tier 2)	3 Low Impact (Tier 3)	1 High Imp
Project Title: Data filename:	Sunset Business Center E:\LVVWD\Sunset Business Center.cck revised.cck	Report date: 12/04/17 Page 6 of 9	Project Title: Sunset Business Cen Data filename: E:\LVVWD\Sunset Bu

COMcheck Software Version 4.0.7.1 **Inspection Checklist**

Energy Code: 2012 IECC Requirements: 100.0% were addressed directly in the COM*check* software

Section # & Req.ID	Plan Review	Complies?	
C103.2 [PR1] ¹	Plans and/or specifications provide all information with which compliance can be determined for the building envelope and document where exceptions to the standard are claimed.	□Complies □Does Not □Not Observable □Not Applicable	Requirement will
C406 [PR9] ¹	Plans, specifications, and/or calculations provide all information with which compliance can be determined for the additional energy efficiency package options.	Complies Does Not Not Observable Not Applicable	Requirement will
C402.3.1 [PR10] ¹	The vertical fenestration area <= 30 percent of the gross above-grade wall area.	Complies Does Not Not Observable Not Applicable	Requirement will
C402.3.1 [PR11] ¹	The skylight area <= 3 percent of the gross roof area.	Complies Does Not Not Observable Not Applicable	Requirement will
C402.3.2 [PR14] ¹	In enclosed spaces > 10,000 ft2 directly under a roof with ceiling heights >15 ft. and used as an office, lobby, atrium, concourse, corridor, storage, gymnasium/exercise center, convention center, automotive service, manufacturing, non- refrigerated warehouse, retail store, distribution/sorting area, transportation, or workshop, the following requirements apply: (a) the daylight zone under skylights is >= half the floor area; (b) the skylight area to daylight zone is >= 3 percent with a skylight VT >= 0.40; or a minimum skylight effective aperture >= 1 percent.	□Complies □Does Not □Not Observable □Not Applicable	Exception: Requ
C402.3.2. 2 [PR15] ¹	Skylights in office, storage, automotive service, manufacturing, non-refrigerated warehouse, retail store, and distribution/sorting area have a measured haze value > 90 percent unless designed to exclude direct sunlight.	□Complies □Does Not □Not Observable □Not Applicable	Exception: Requ

1	High Impact (Tier 1)	2	Medium Impact
Current Due	iness Contex		

Additional Comments/Assumptions:

ect Title:	Sunset Business Center		Report date: 12/04/17
	E:\LVVWD\Sunset Business Center.cck	revised.cck	Page 3 of 9
Section # & Req.ID	Framing / Rough-In Inspection	Complies?	Comments/Assumptions
C402.4.3, C402.4.4 [FR18] ³	Factory-built fenestration and doors are labeled as meeting air leakage requirements.	Complies Does Not Not Observable Not Applicable	Requirement will be met.
C402.4.7 [FR17] ³	Vestibules are installed on all building entrances. Doors have self-closing devices.	Complies Does Not Not Observable Not Applicable	Exception: Doors that open directly from a space =3000 ft2.
C402.3.3, C402.3.4 [FR8] ¹	Vertical fenestration U-Factor.	Complies Does Not Not Observable Not Applicable	See the Envelope Assemblies table for values.
C402.3.3 [FR10] ¹	Vertical fenestration SHGC value.	Complies Does Not Not Observable Not Applicable	See the Envelope Assemblies table for values.
C303.1.3 [FR12] ²	Fenestration products rated in accordance with NFRC.	Complies Does Not Not Observable Not Applicable	Exception: Default values are used.
C303.1.3 [FR13] ¹	Fenestration products are certified as to performance labels or certificates provided.	Complies Does Not Not Observable Not Applicable	Requirement will be met.
C402.2.7 [FR14] ²	U-factor of opaque doors associated with the building thermal envelope meets requirements.	Complies Does Not Not Observable Not Applicable	See the Envelope Assemblies table for values.

ed, weather stripped moisture vapor- ping material to kage.	□Not Observable □Not Applicable	
or some ceiling ation may need to aming Inspection.	□Complies □Does Not □Not Observable □Not Applicable	See the Envelope Assemblies table for values.
nstalled per instructions. Blown or insulation is installed roof slope is <=3 in	□Complies □Does Not □Not Observable □Not Applicable	Requirement will be met.
fs satisfy one of the r-aged solar 0.55 and thermal .75, 3-year-aged solar x >= 64.0, initial year e >= 0.70 and thermal .75, or initial year e index >= 82.0.	□Complies □Does Not □Not Observable □Not Applicable	Exception: Asphaltic Membrane Roof.
Il insulation installed er's instructions.	Complies Does Not Not Observable Not Applicable	Requirement will be met.
be insulation is labeled insulation certificate le and other relevant	□Complies □Does Not □Not Observable □Not Applicable	Requirement will be met.
on is protected from protective material. exposed foundation need to occur during ection.	□Complies □Does Not □Not Observable □Not Applicable	Exception: Requirement does not apply.
ded to meet the roof rements cannot be of a suspended s requirement Ilation is installed	□Complies □Does Not □Not Observable □Not Applicable	Requirement will be met.

Requirement will be met.

pact (Tier 1) 2 Medium Impact (Tier 2) 3 Low Impact (Tier 3)

usiness Center.cck revised.cck

Report date: 12/04/17 Page 7 of 9

Report date: 12/04/17

Comments/Assumptions

Page 2 of 9

 1 High Impact (Tier 1)
 2 Medium Impact (Tier 2)
 3 Low Impact (Tier 3)
 Project Title: Sunset Business Center Data filename: E:\LVVWD\Sunset Business Center.cck revised.cck

Text in the "Comments/Assumptions" column is provided by the user in the COMcheck Requirements screen. For each requirement, the user certifies that a code requirement will be met and how that is documented, or that an exception

rence to that table is provided.					
Comments/Assumptions					
will be met.					
will be met.					
will be met.					
will be met.					
will be met.					
equirement does not apply.					
equirement does not apply.					

	1 High Impact (Tier 1) 2 Medium Impact (Tier 2)	3 Low Impact (Ti	er 3)		
Project Title:	Sunset Business Center		Report date:	12/04	1/17
Data filename:	E:\LVVWD\Sunset Business Center.cck revised.cck		Page	4 of	1

Section # Footing / Foundation Inspection Complies?

Complies

Not Observable

Not Applicable

Does Not

C403.2.8. Exterior insulation protected against

landscaping and equipment

maintenance activities.

Additional Comments/Assumptions:


[FO6]¹

damage, sunlight, moisture, wind,

Comments/Assumptions

Requirement will be met.


Section # & Req.ID	Final Inspection	Complies?	Comments/Assumptions
C402.4.6 [FI37] ¹	Weatherseals installed on all loading dock cargo doors.	Complies Does Not Not Observable	Exception: Requirement does not apply.
C402.4.8 [FI26] ³	Recessed luminaires in thermal envelope to limit infiltration and be IC rated and labeled. Seal between interior finish and luminaire housing.	Complies Does Not Not Observable	Requirement will be met.

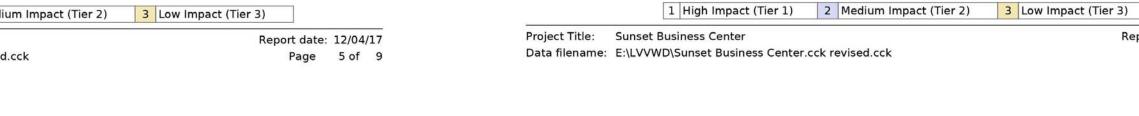




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----seal:

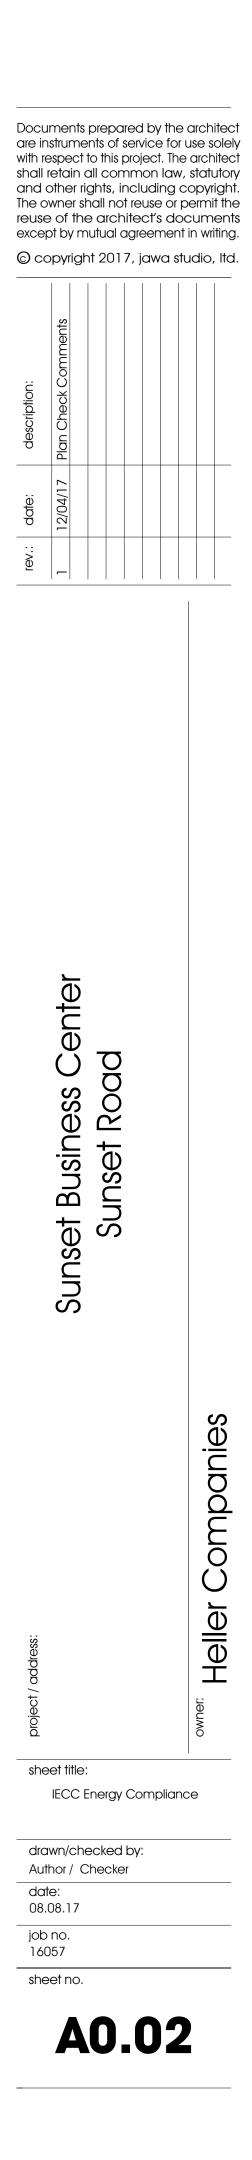

Report date: 12/04/17

Page 8 of 9

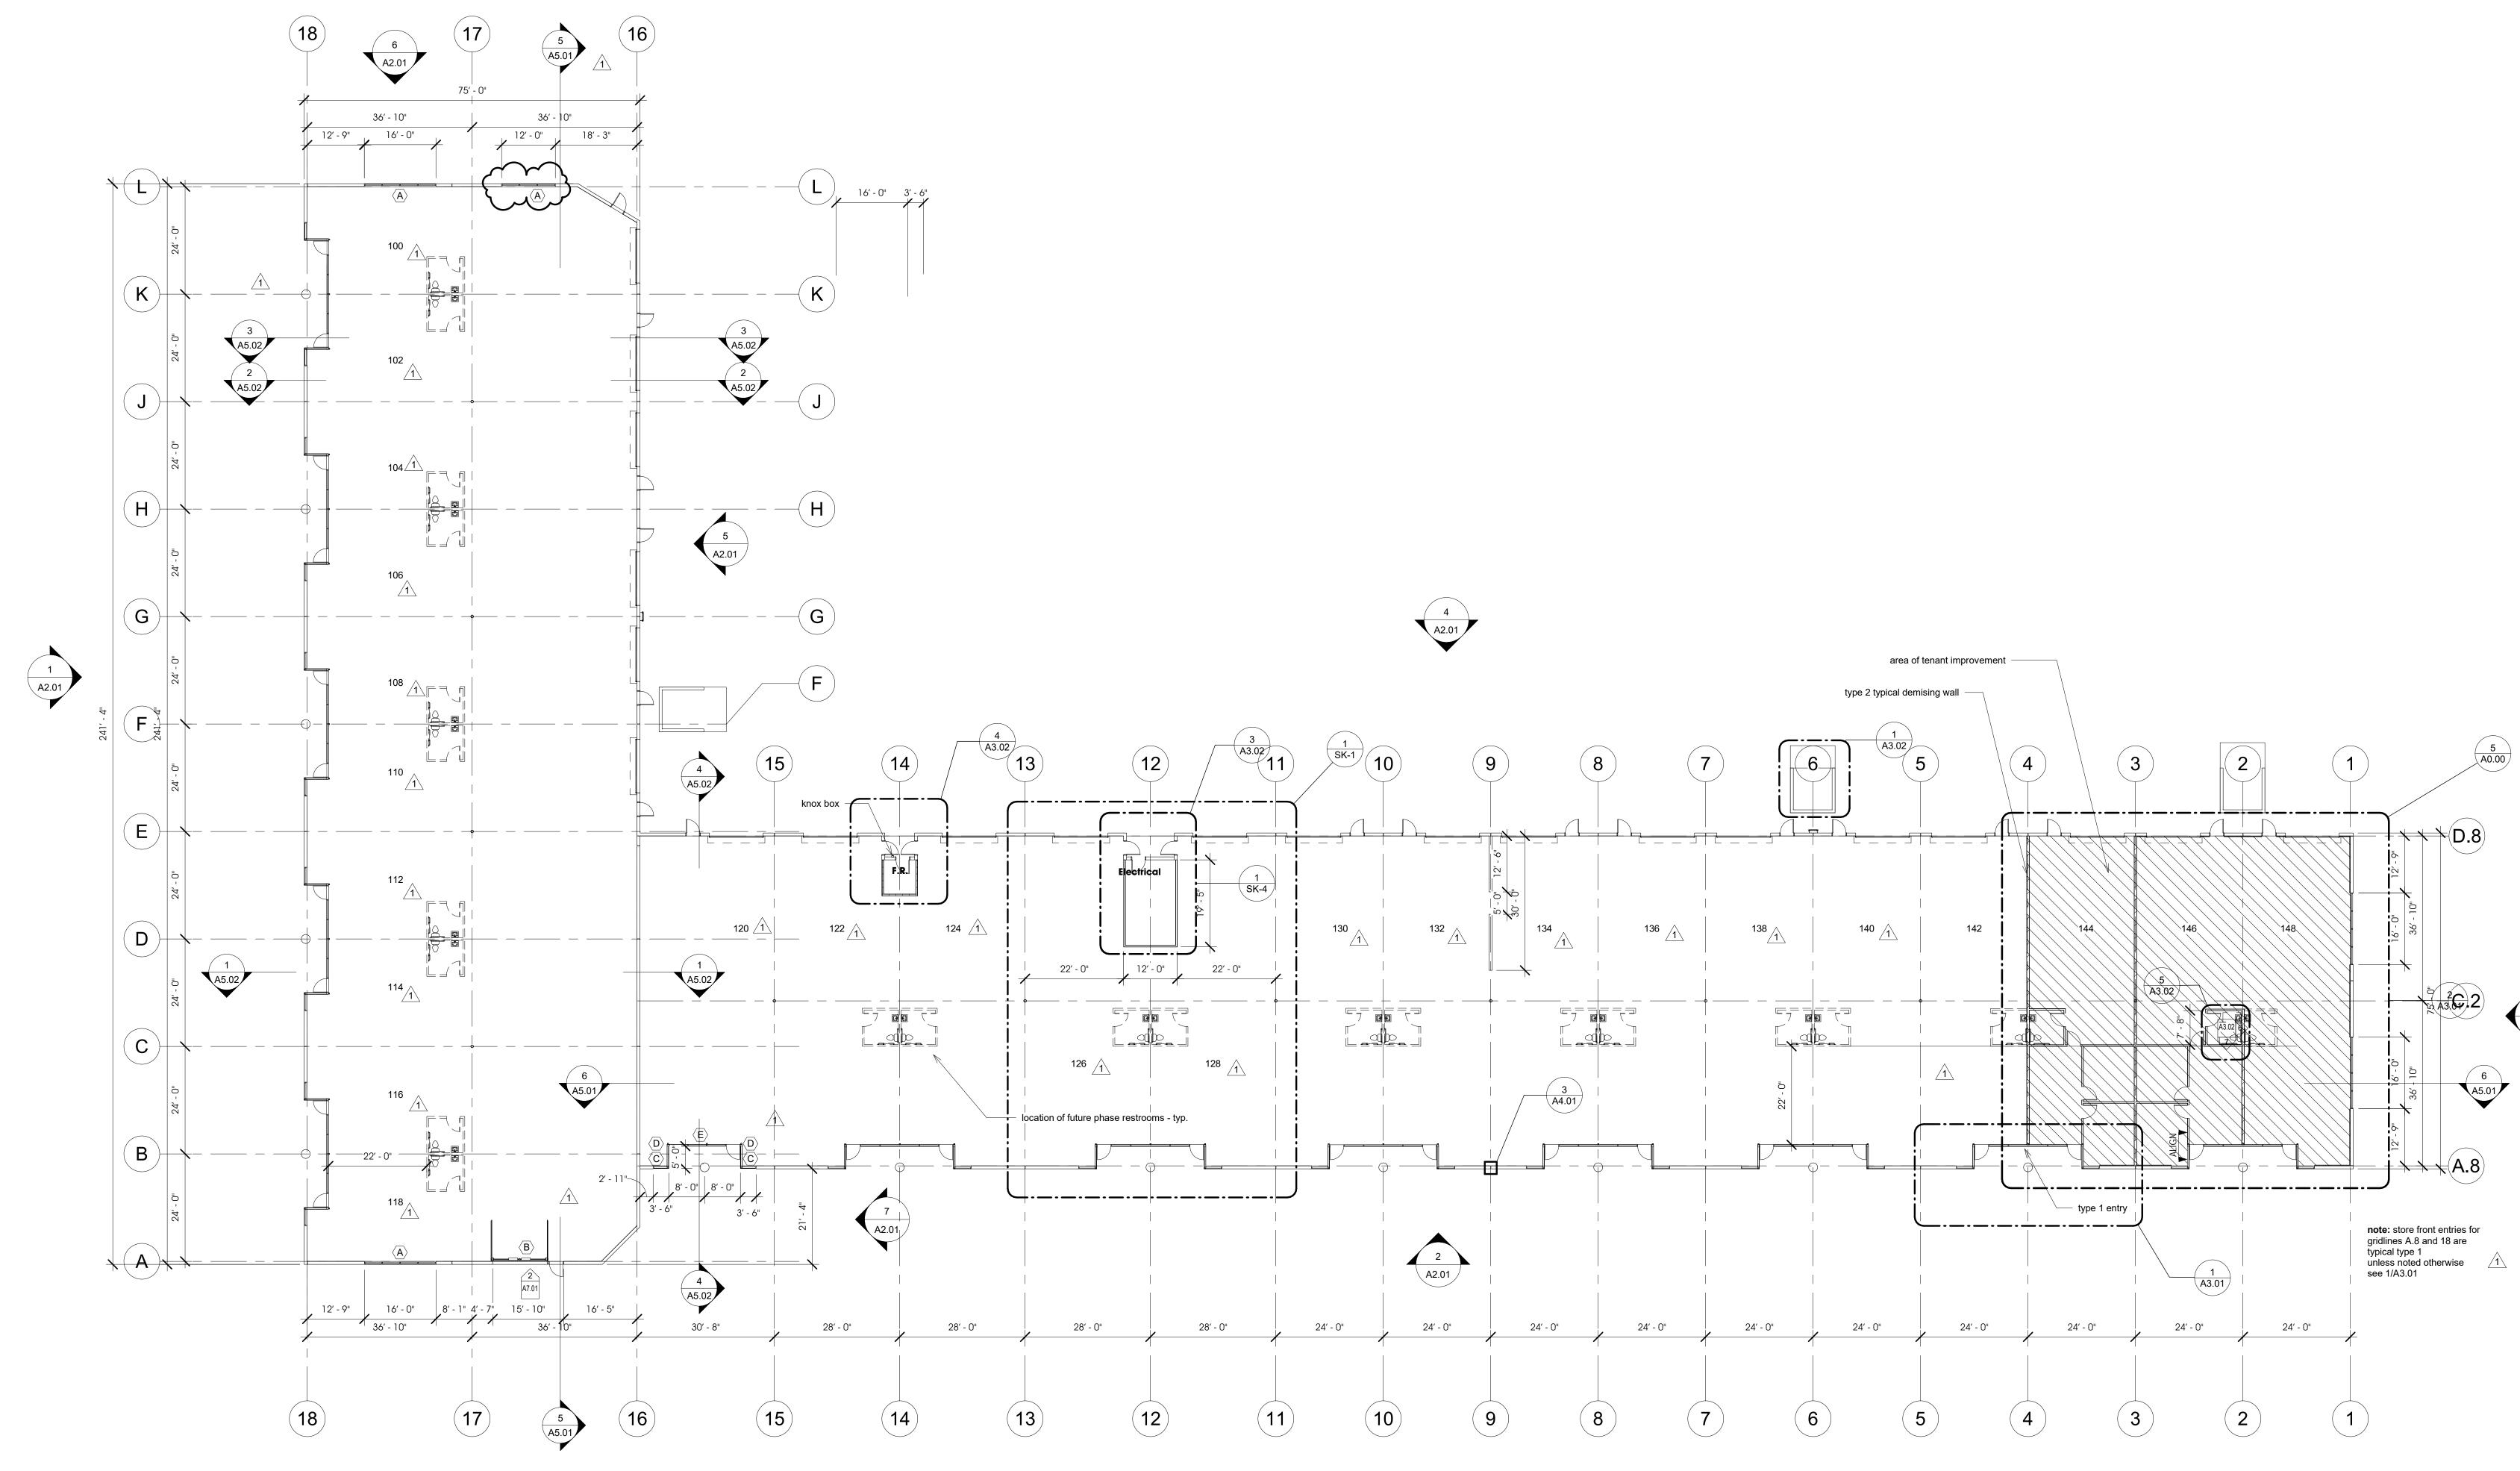

First Floor Plan - Building 100 1/16" = 1'-0"






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----seal:





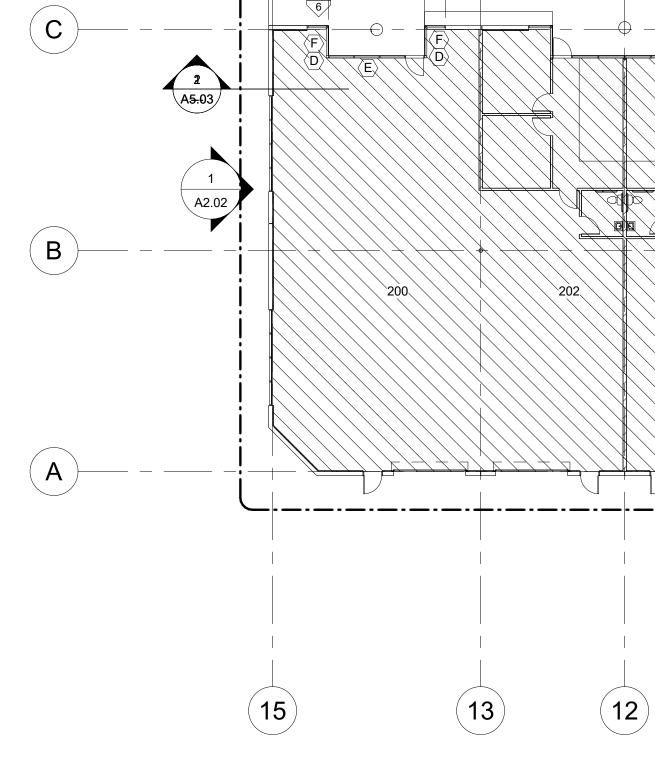

(15)


| 9' - 4"

(13)

34' - 8"

16' - 0" 3' - {5' - 10"

First Floor Plan - Building 200

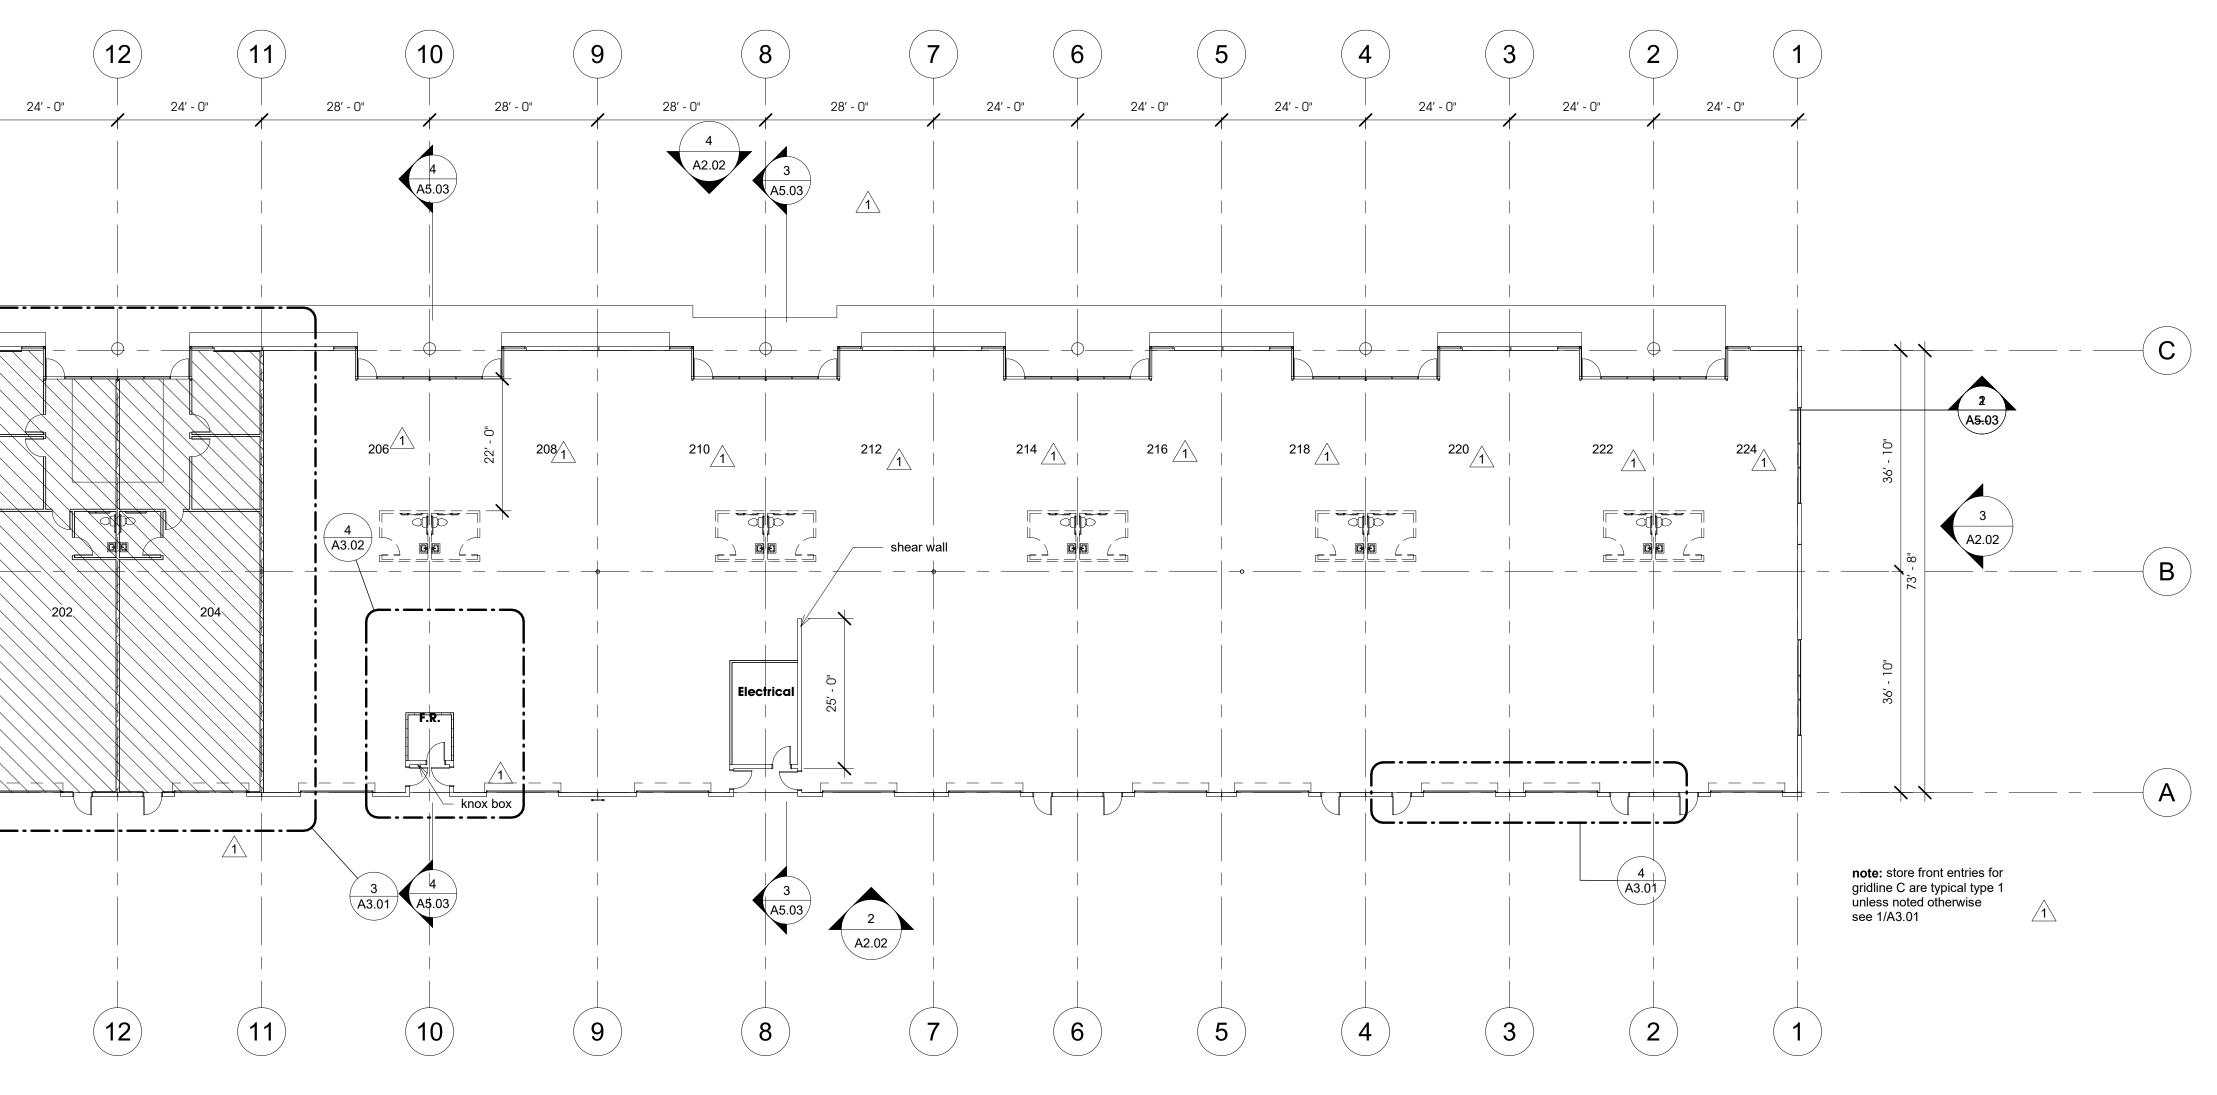






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consultant:







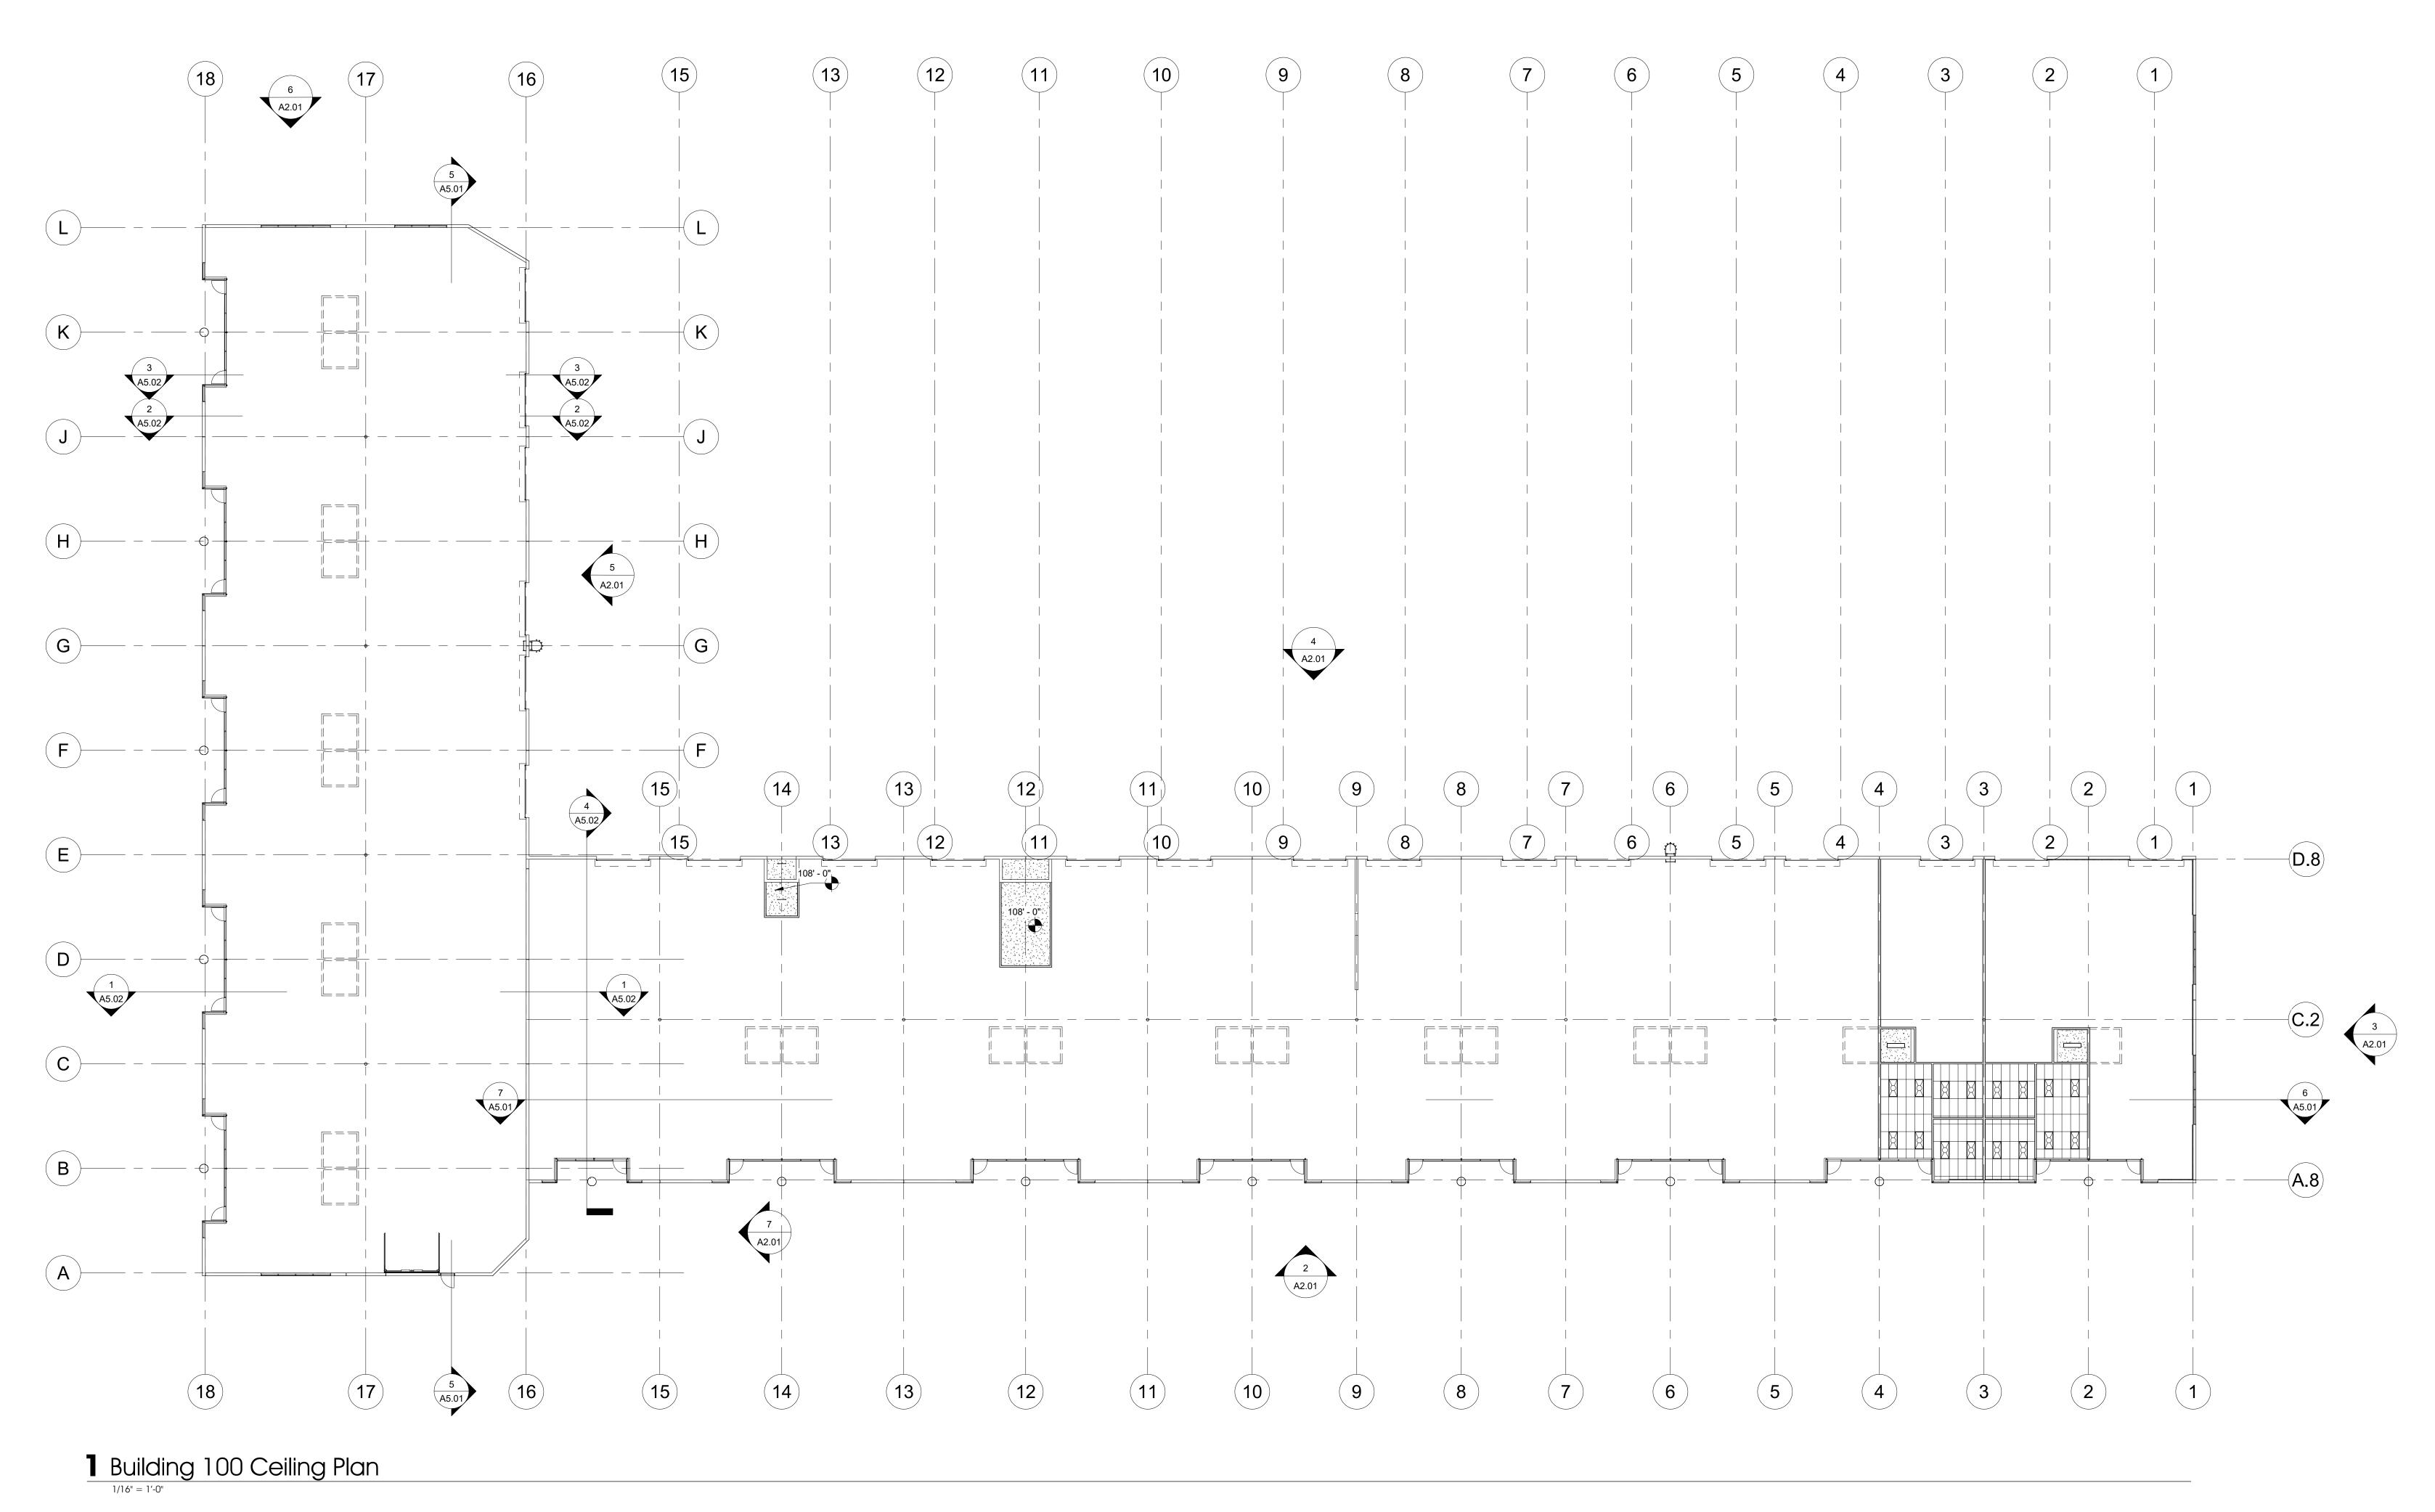


mail@jawastudio com



consultant:



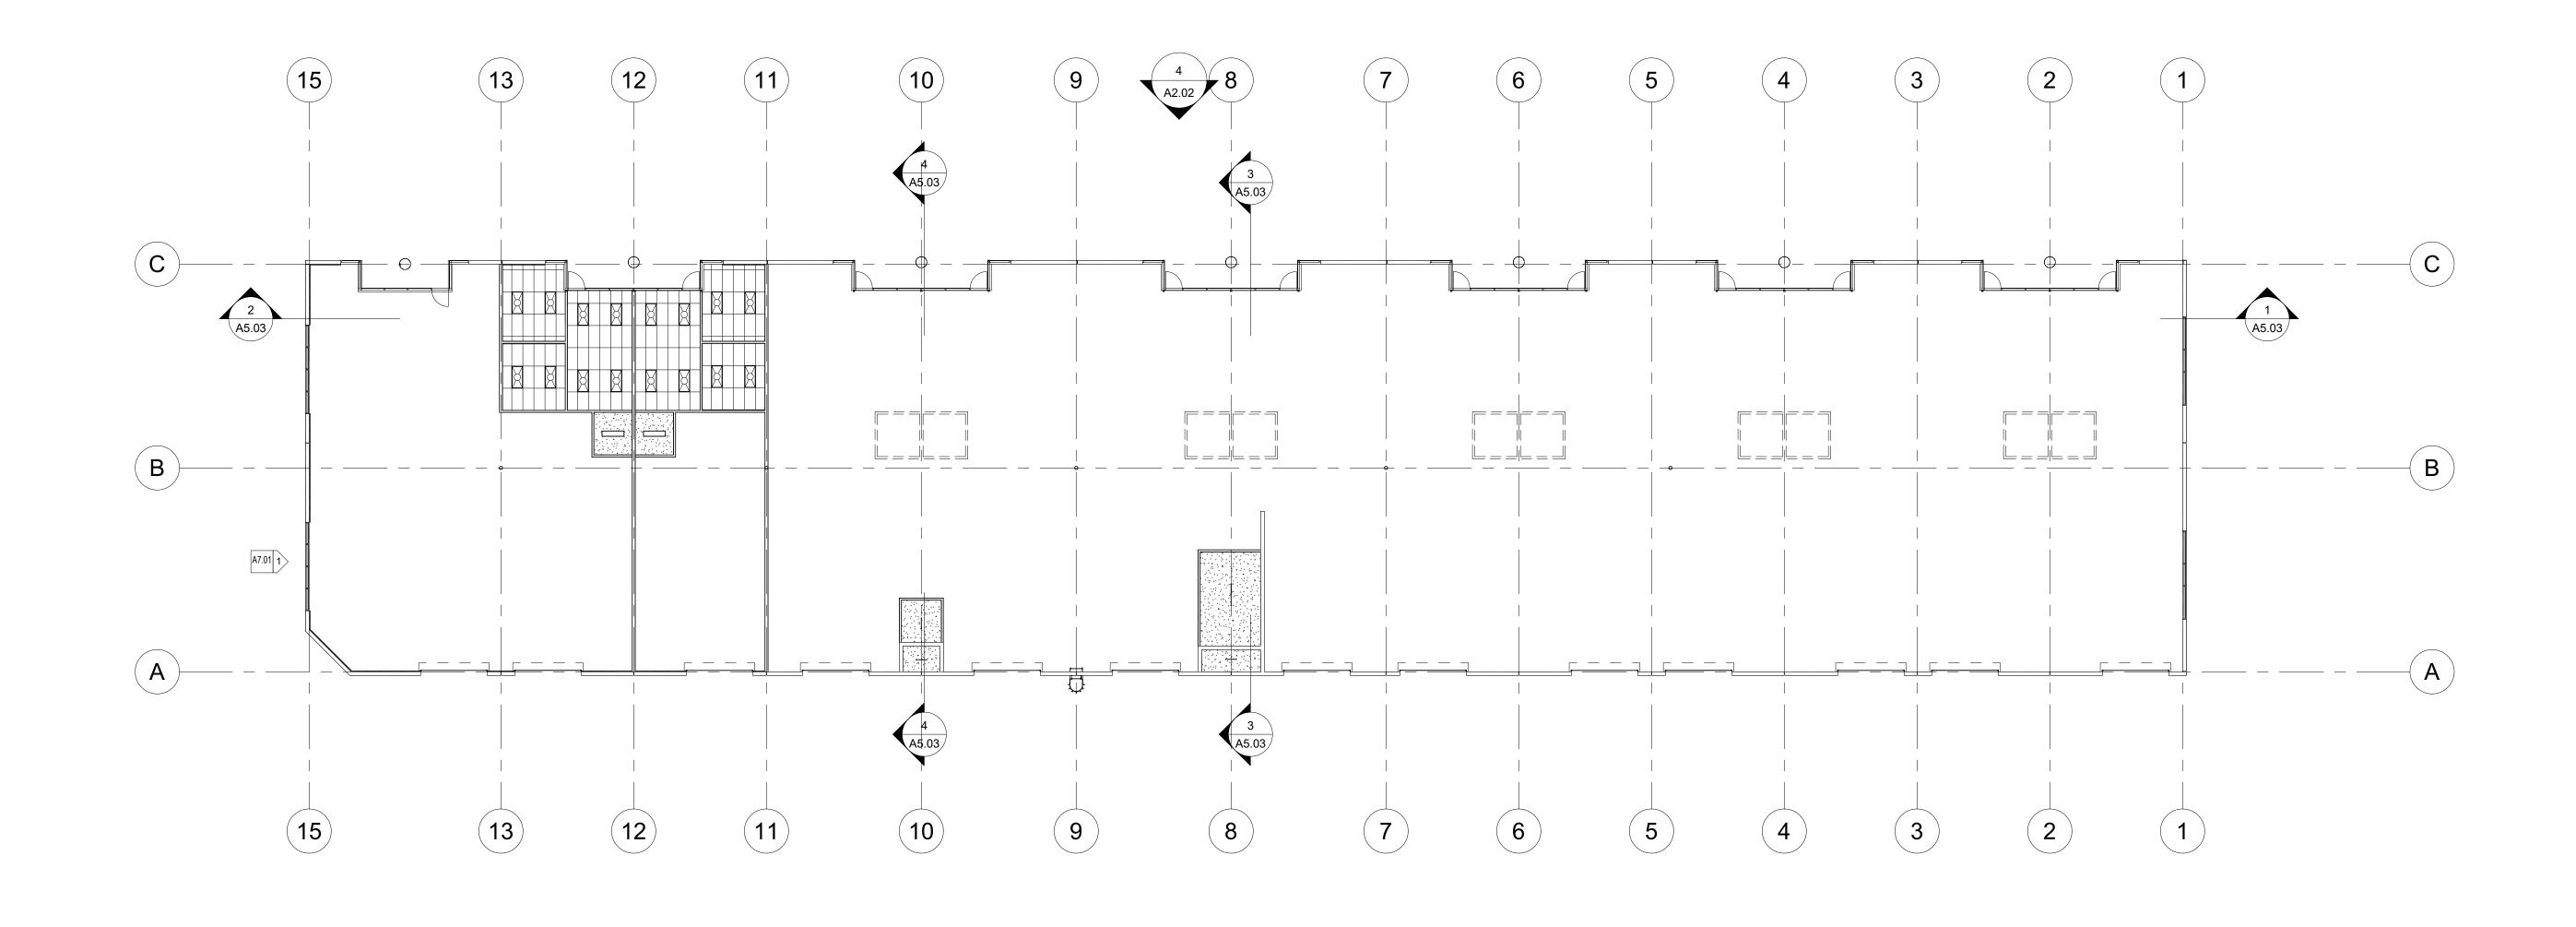








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consultant:





Building 100 Roof Plan

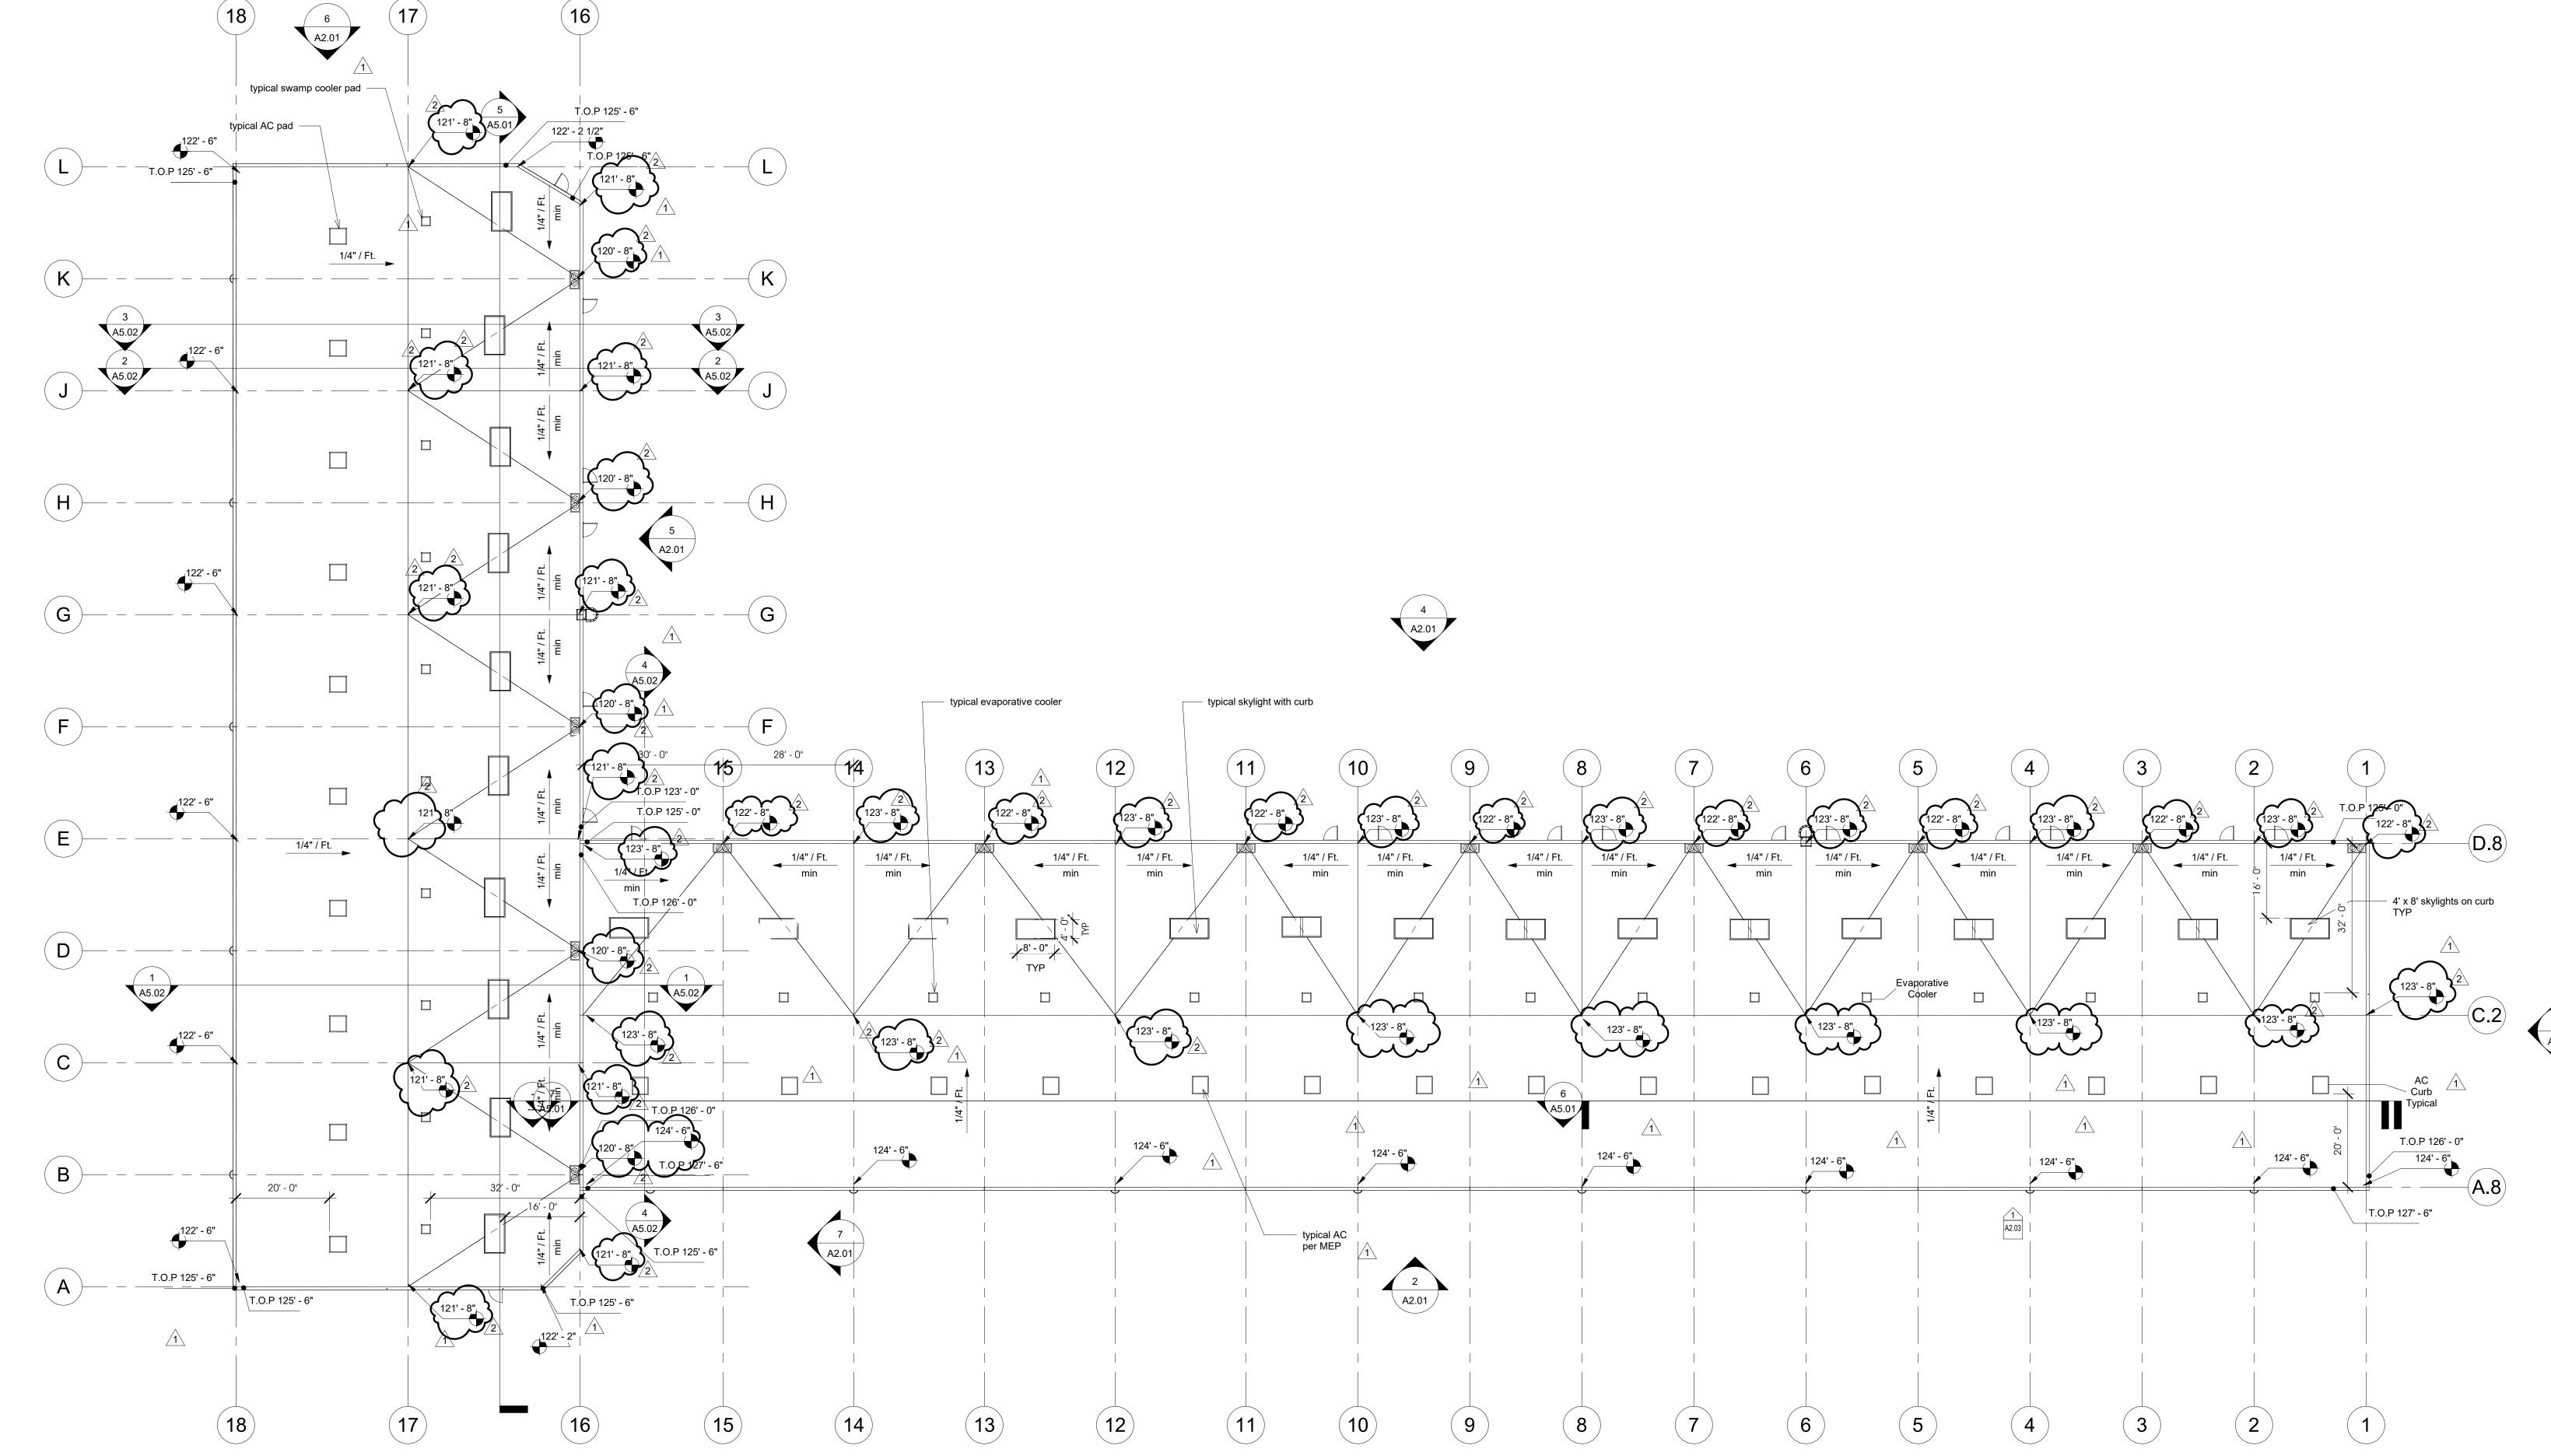




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seal:





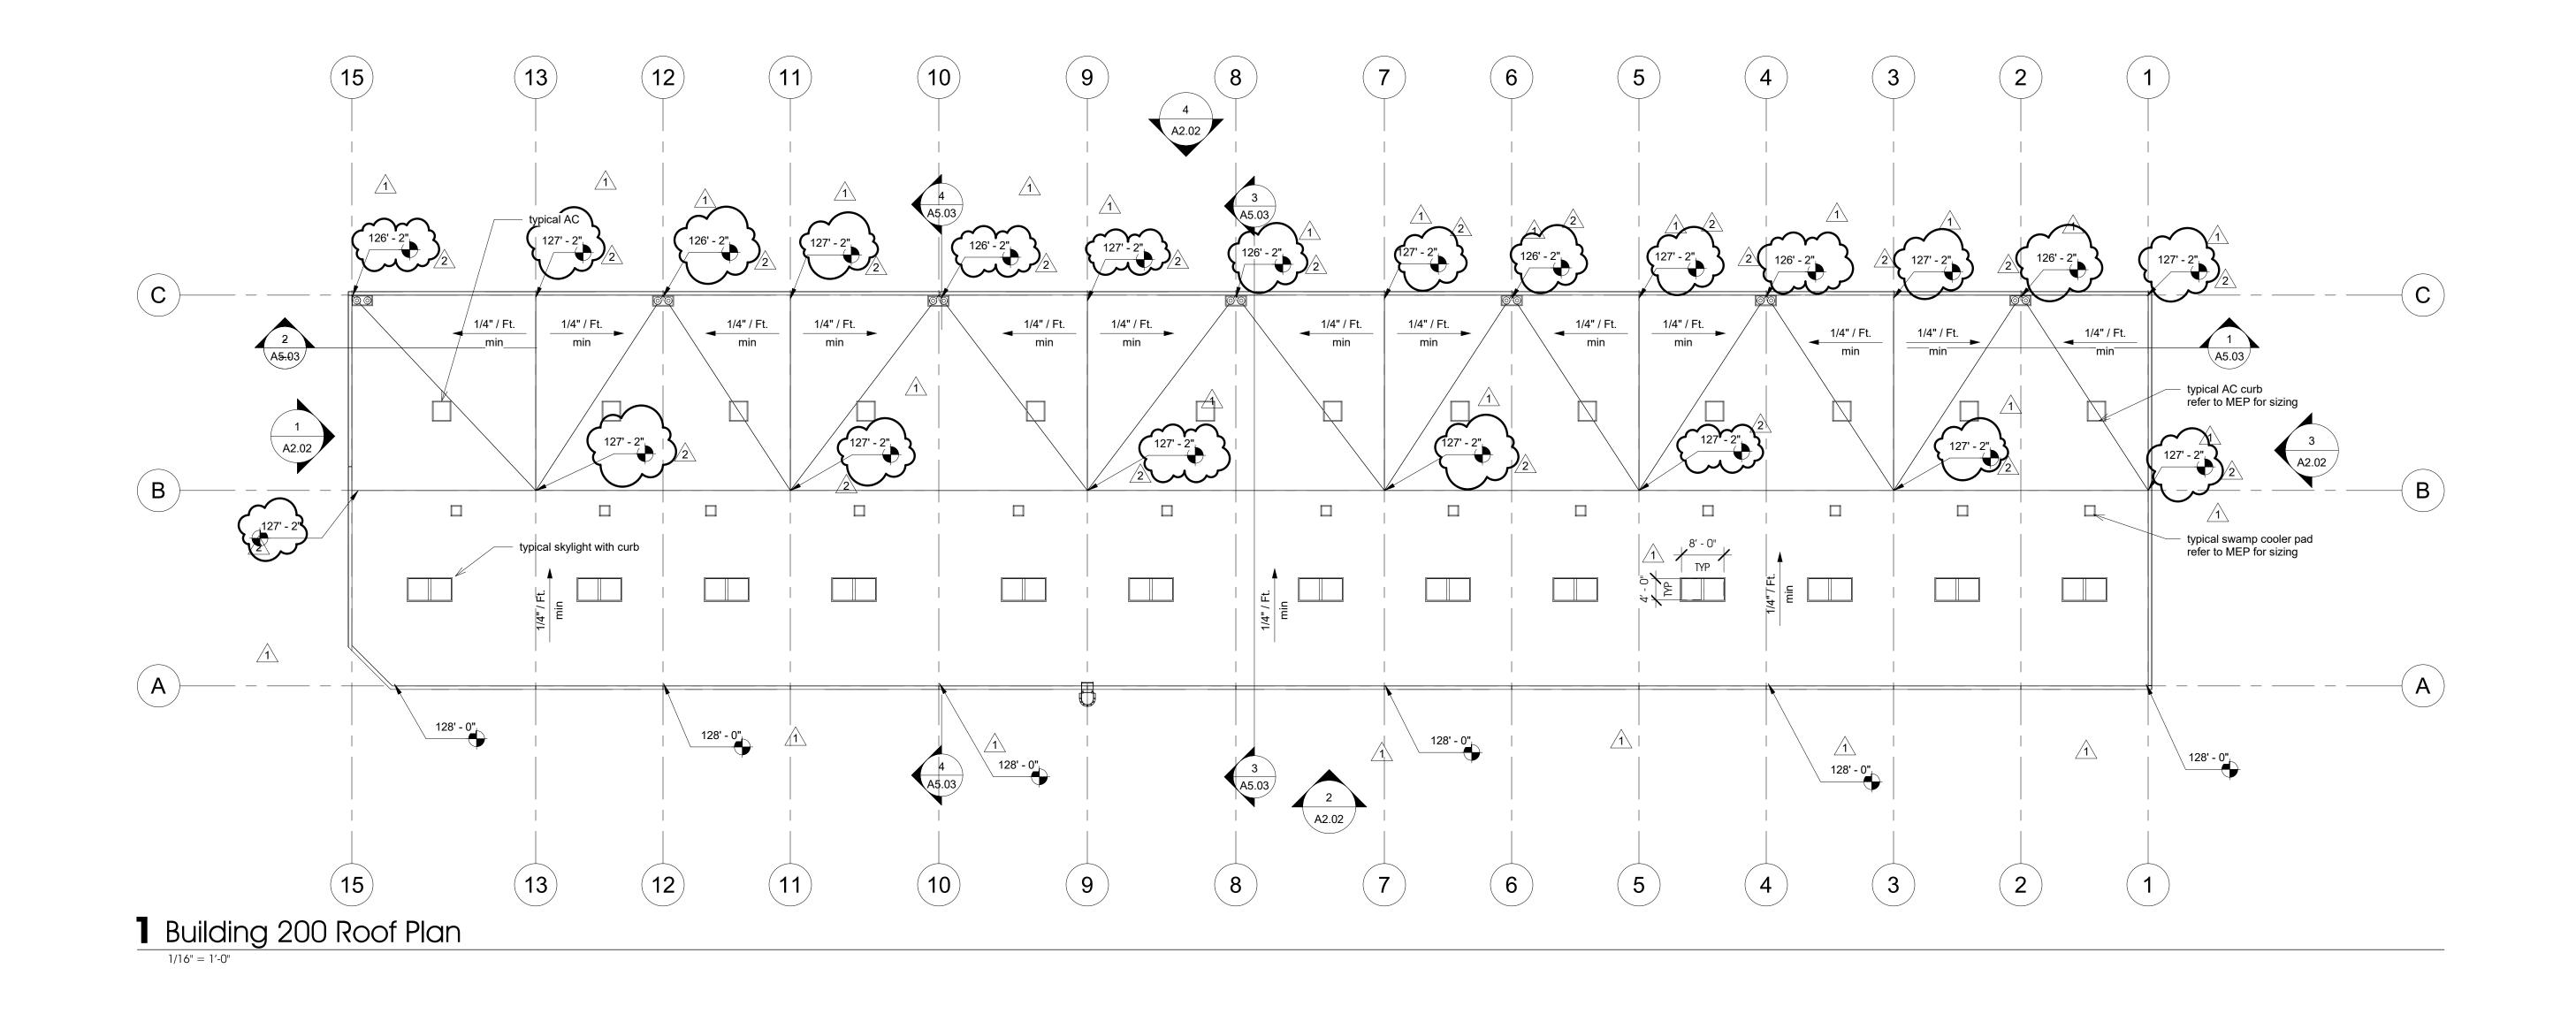




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seal:






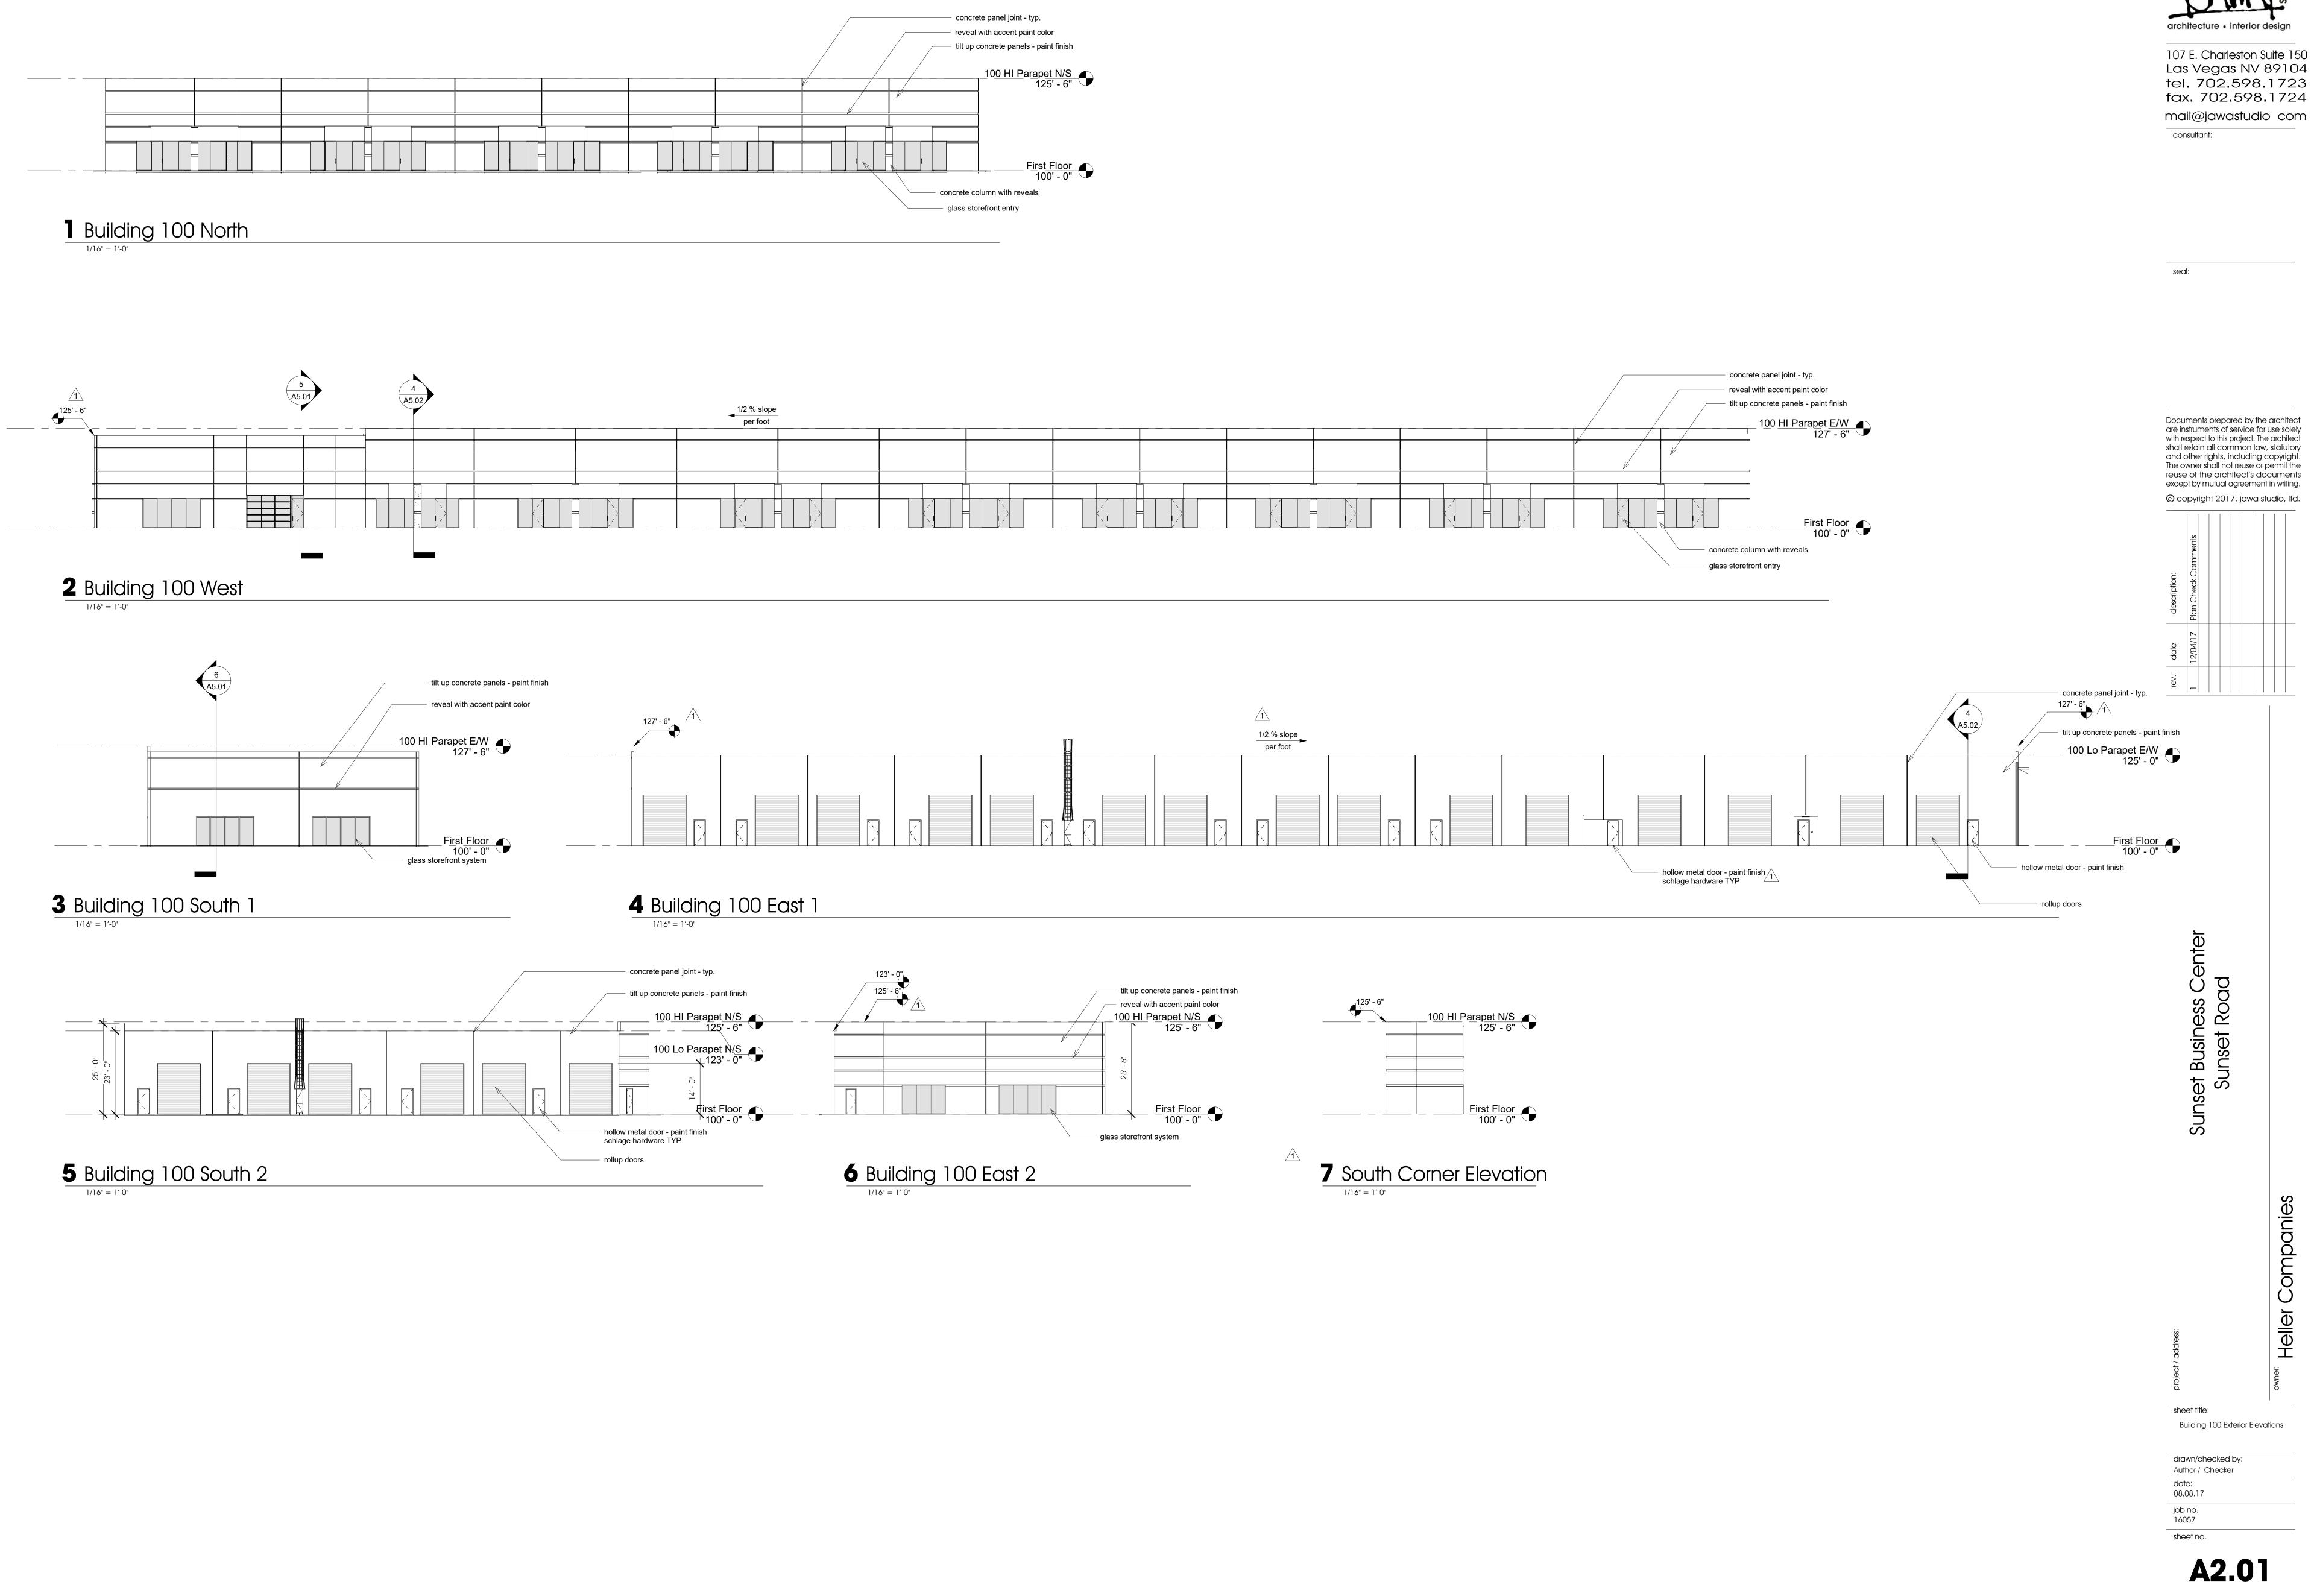


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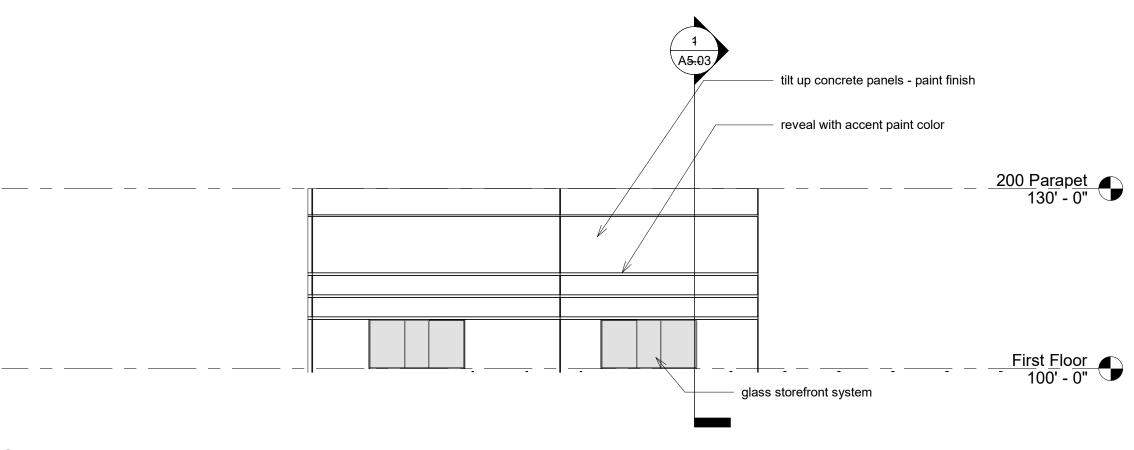
0ropbox(01 JAWA STUDIO LAS VEGAS)(2016)16057 Heller Companies - Sunset Site)16057 heller companies - sunset business center cd rev2.

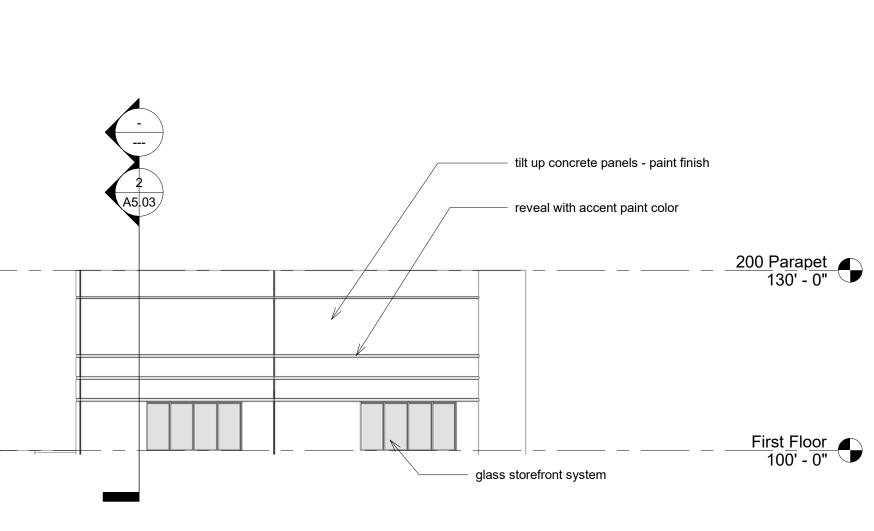


Building 200 North

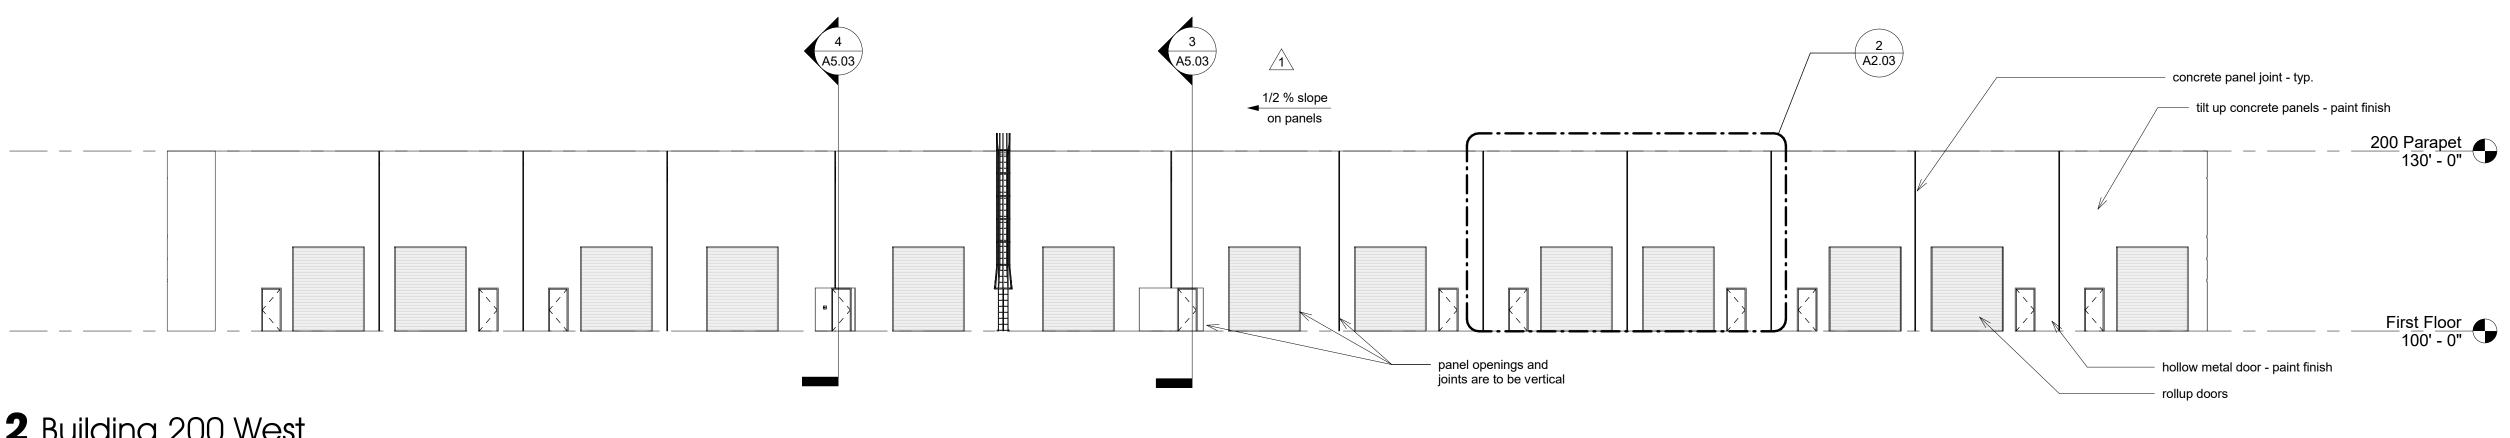

2 Building 200 West



3 Building 200 South

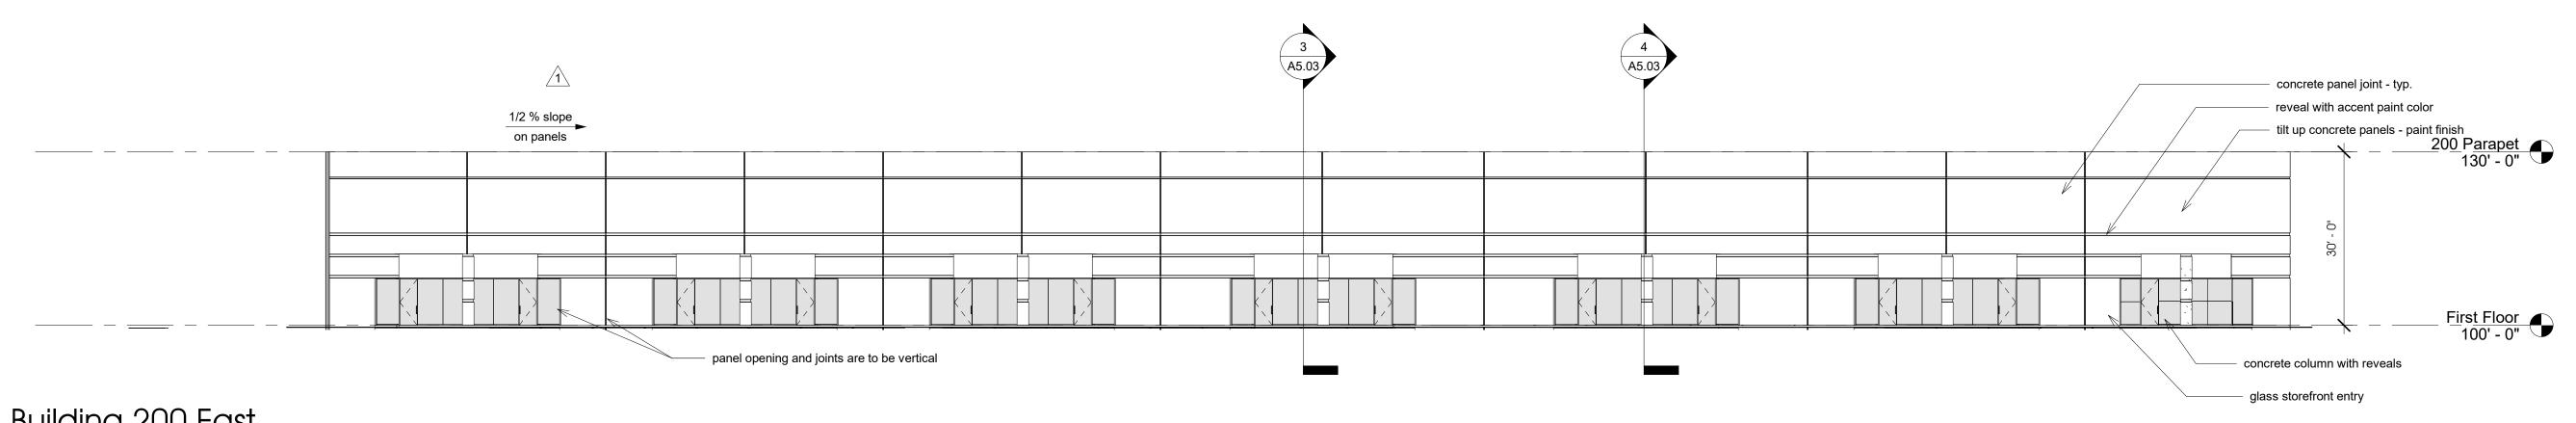


4 Building 200 East




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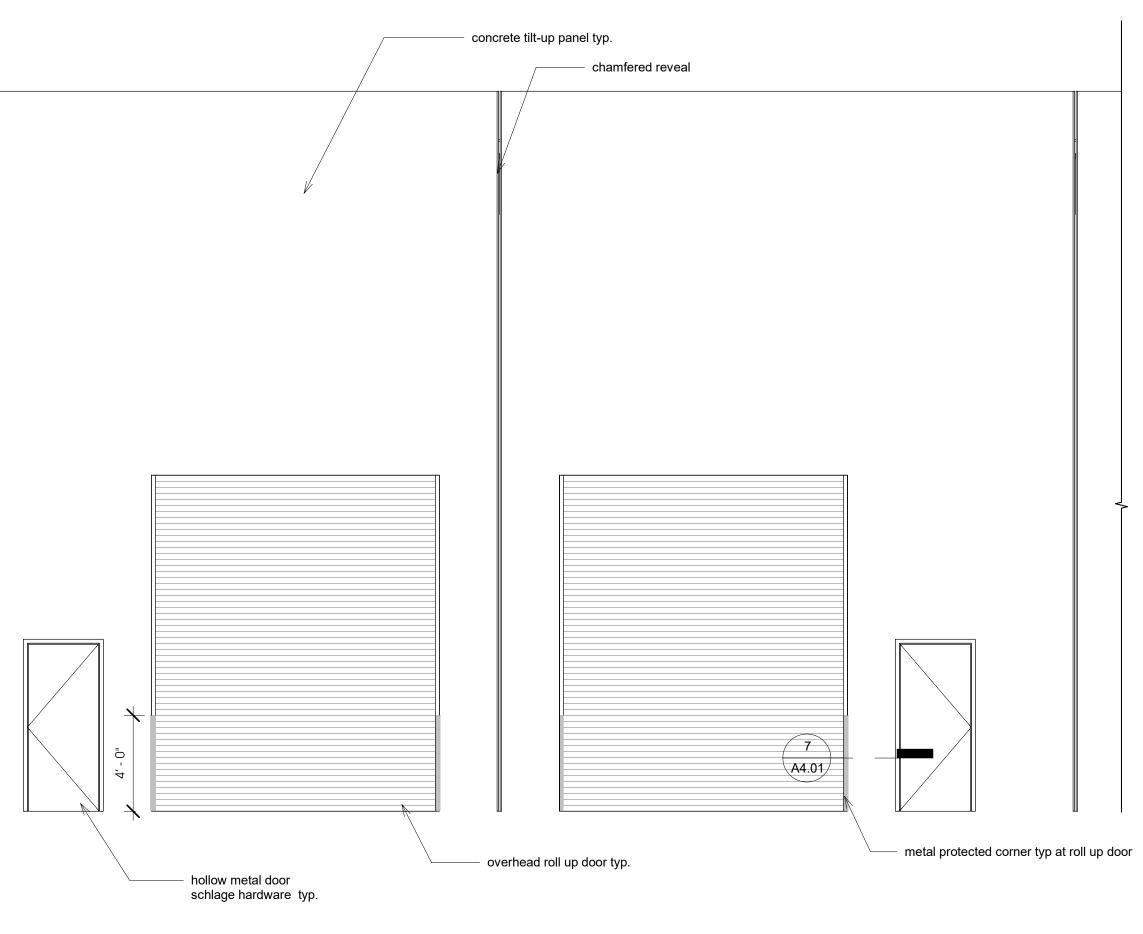


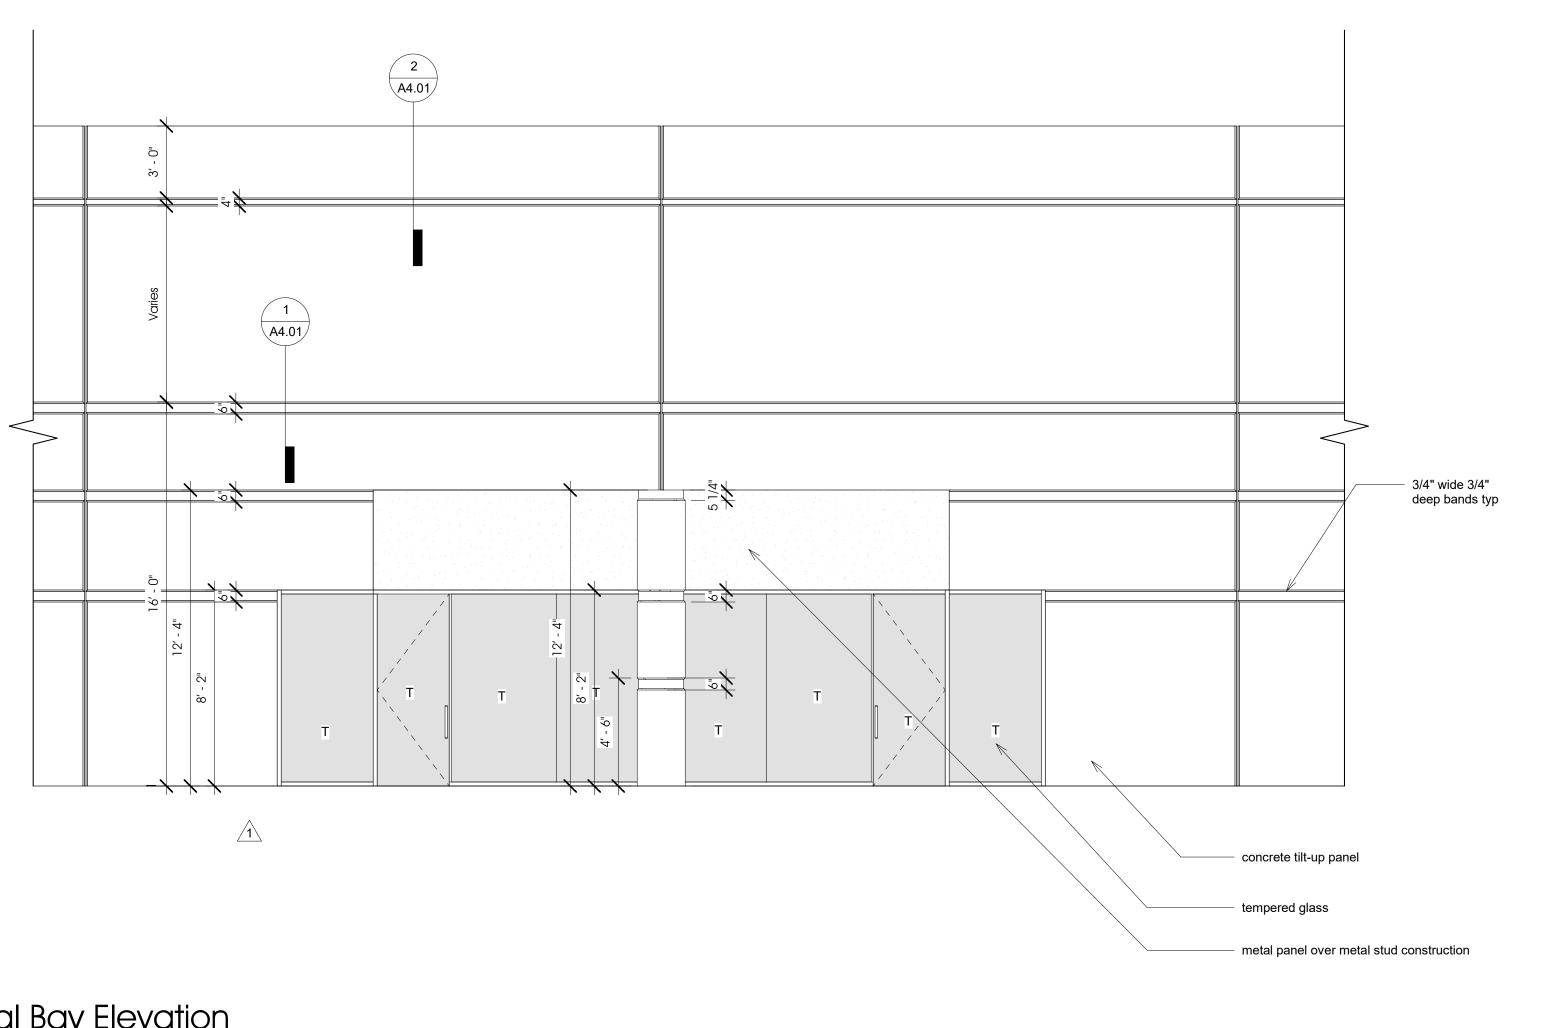

Typical Bay Elevation 1/4" = 1'-0"

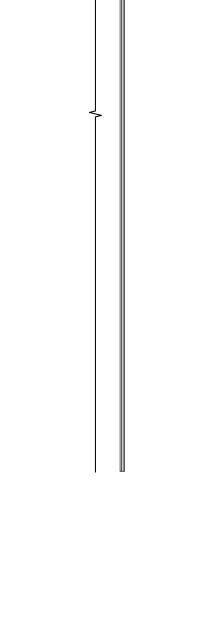


2 Typical Garage Elevation $\frac{1}{4''} = 1' \cdot 0''$







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seal:



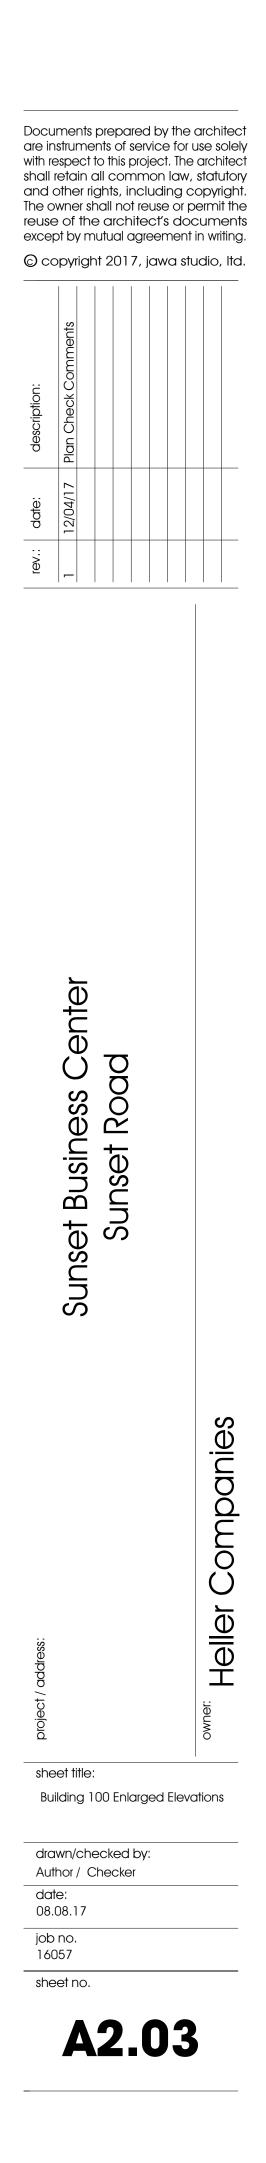


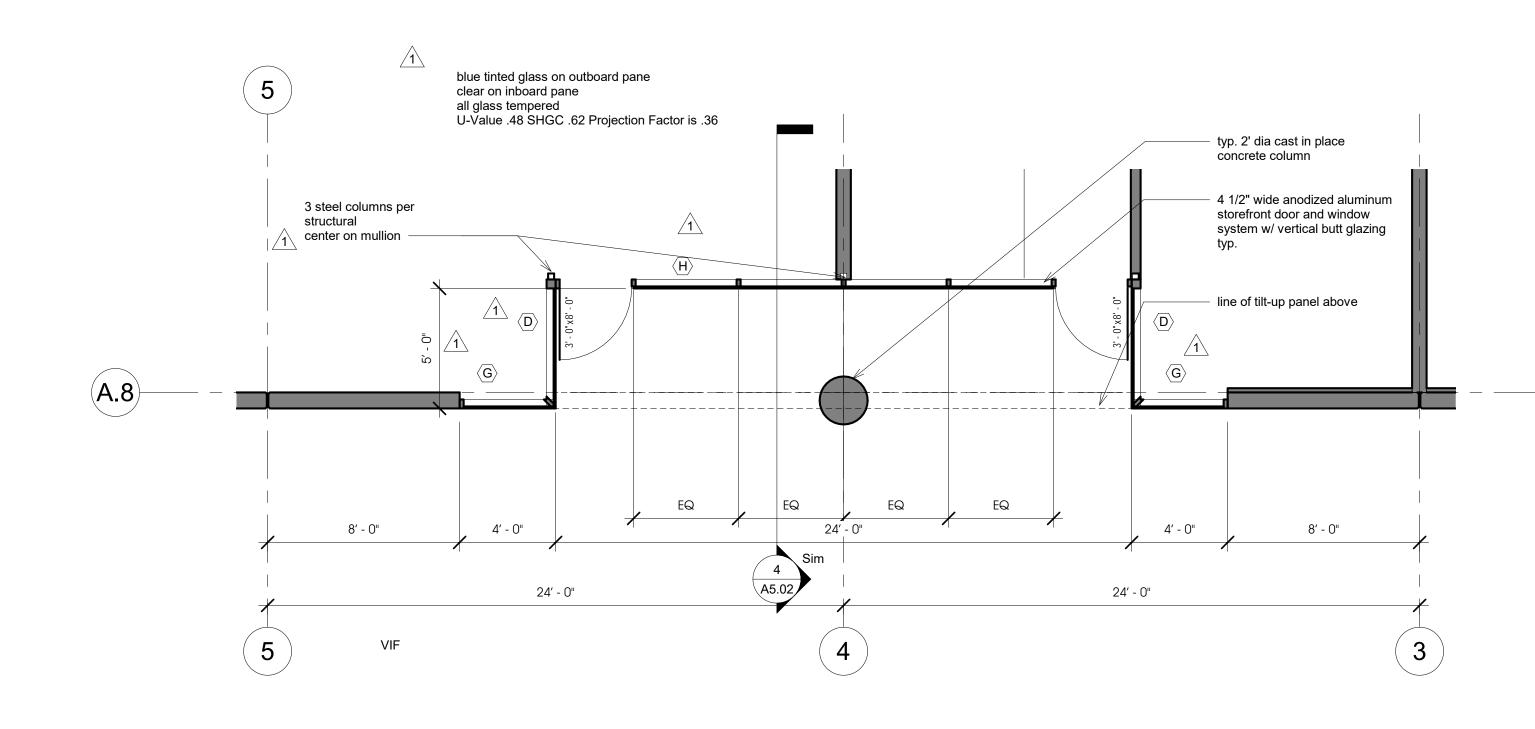Tirst Floor - Building 100 - Typical Type 1 Entry

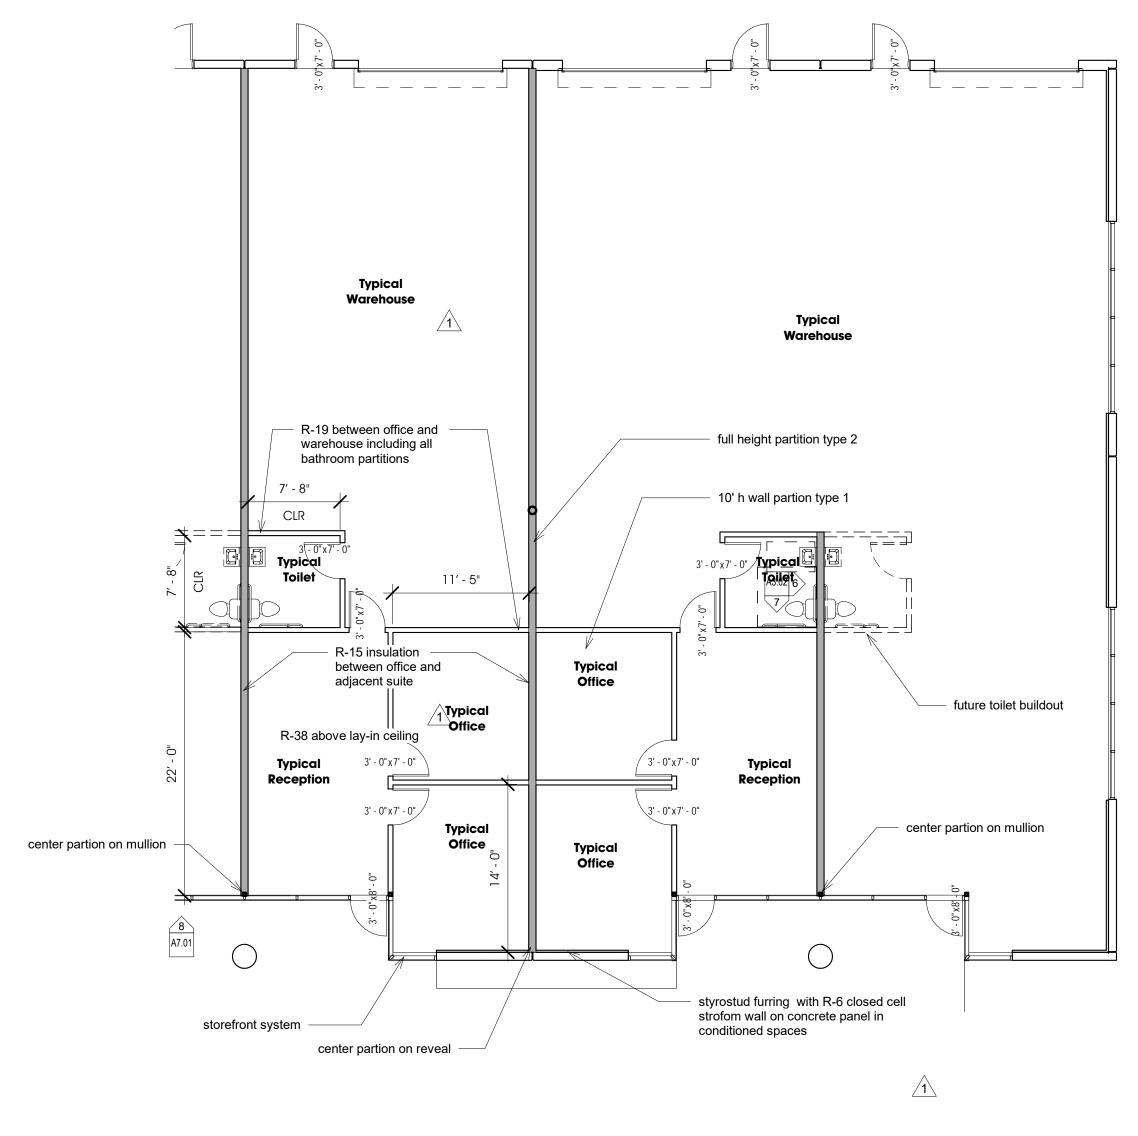


2 Unit- Building 100 - Typical Buildout

1/8" = 1'-0"

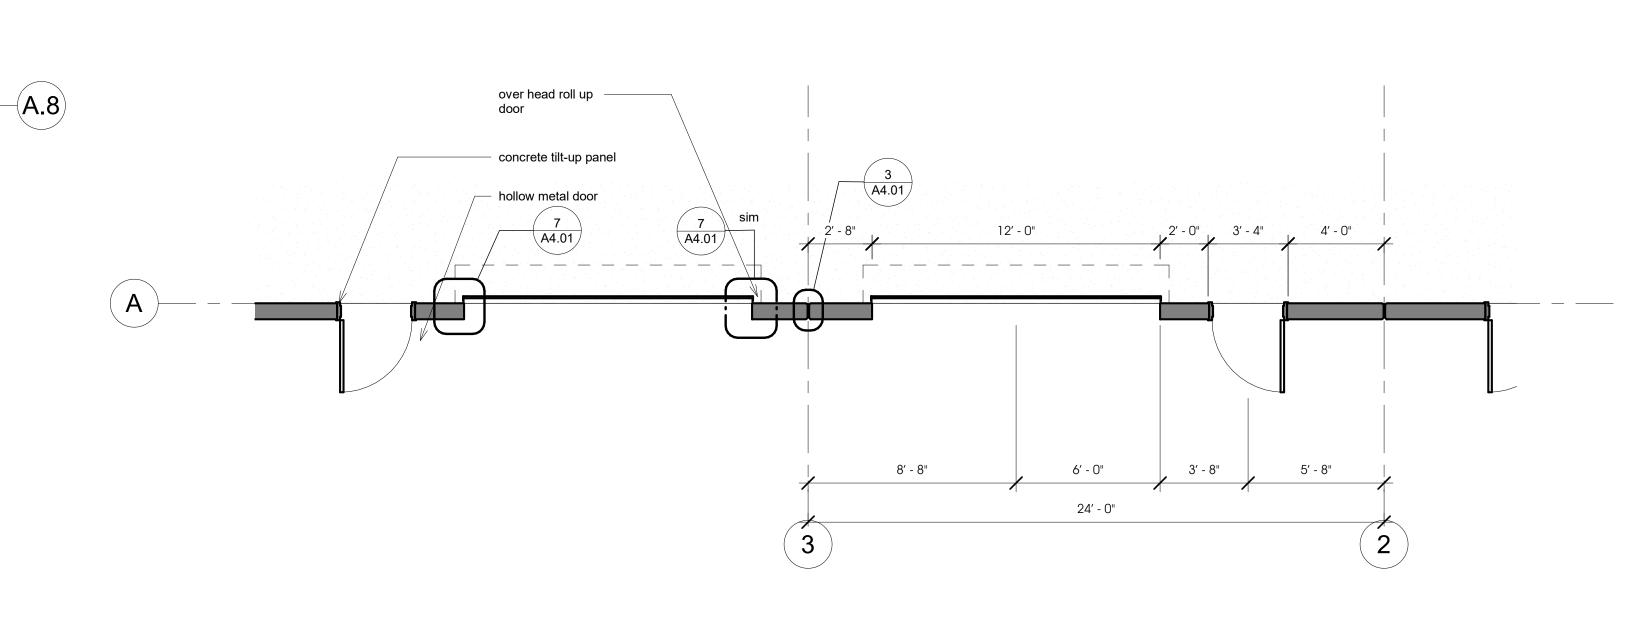



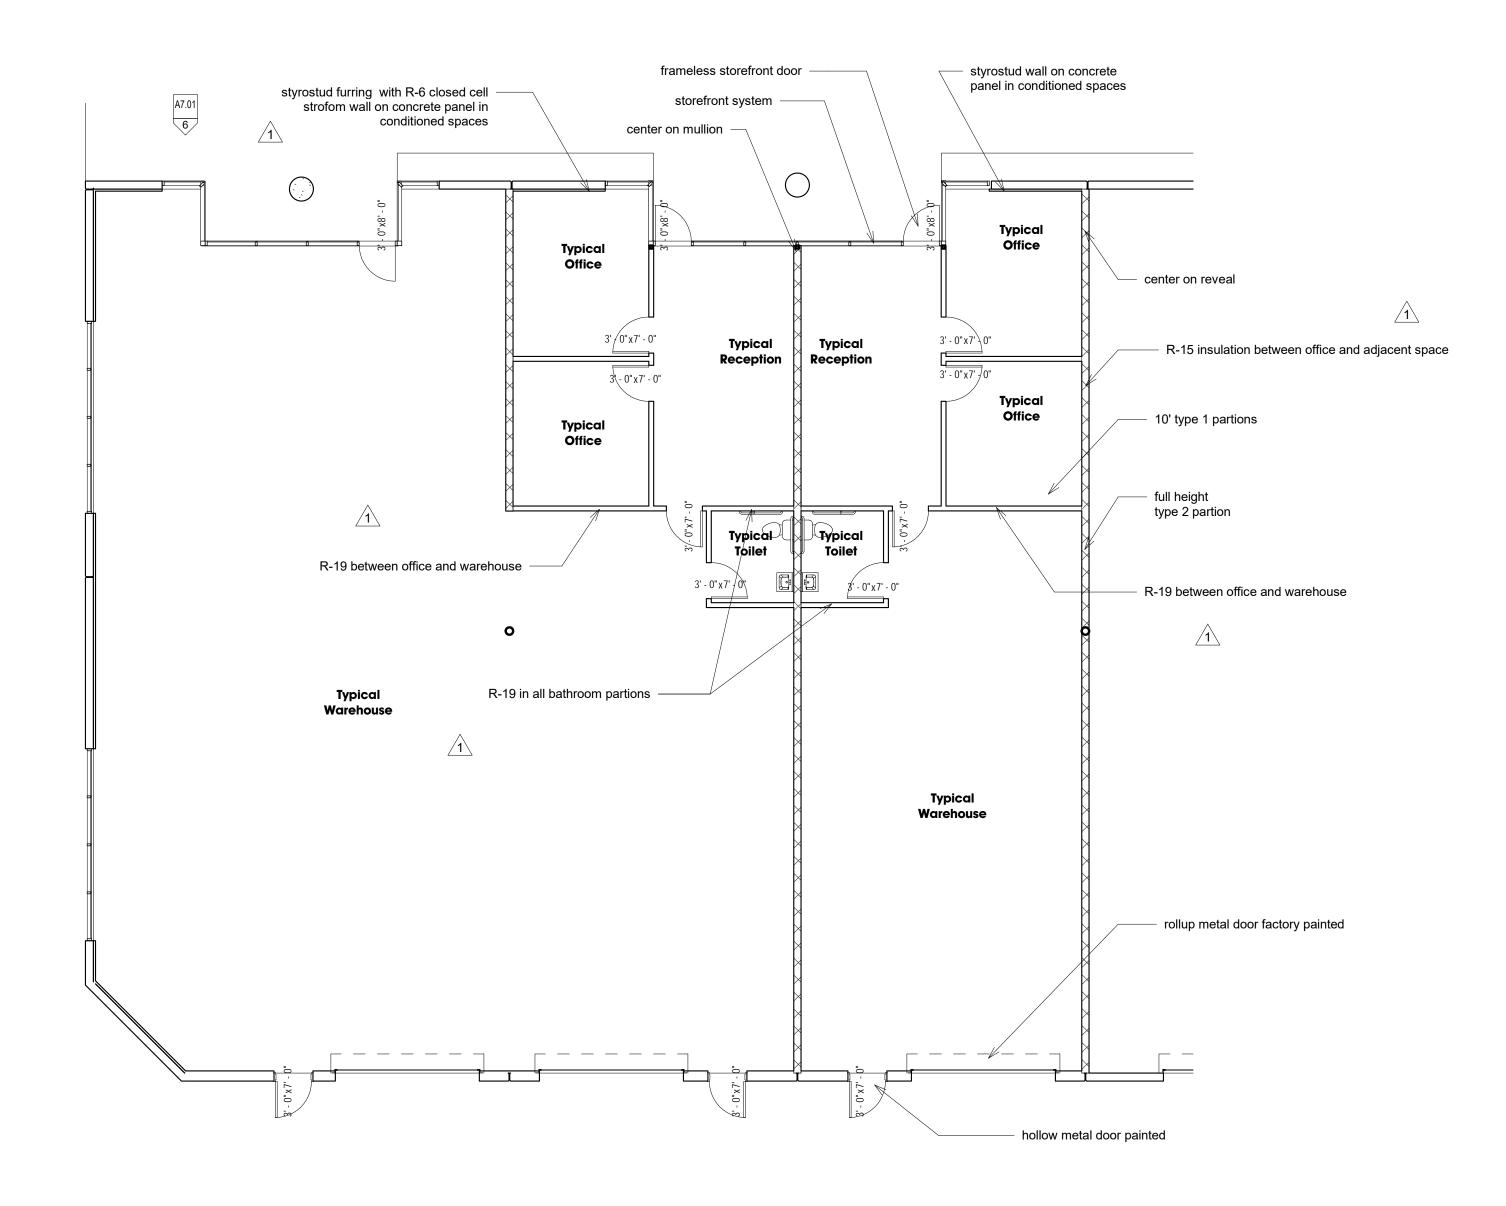







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_____ seal:




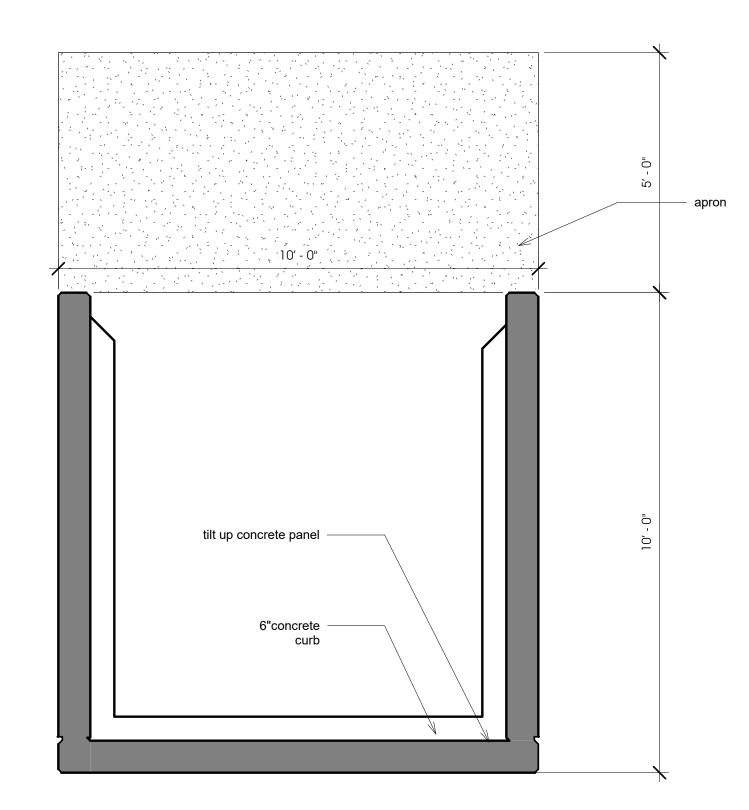


Trash Enclosure Plan $\frac{1}{1/2''} = 1' \cdot 0''$

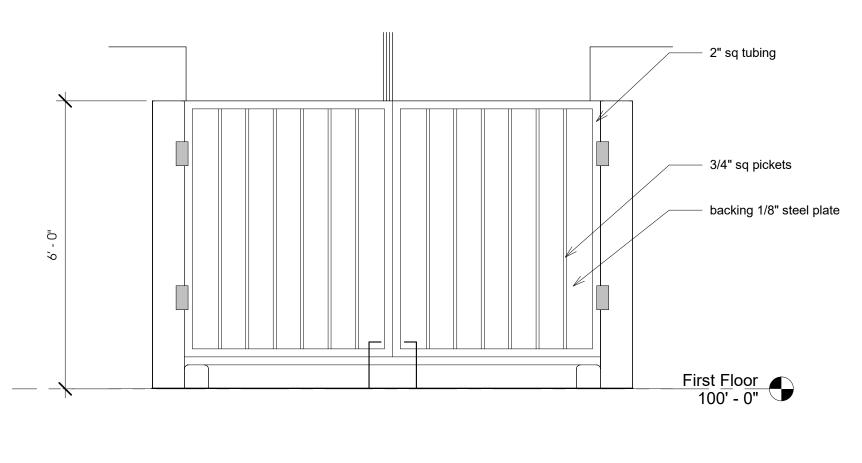


2 Typical Trash Enclosure

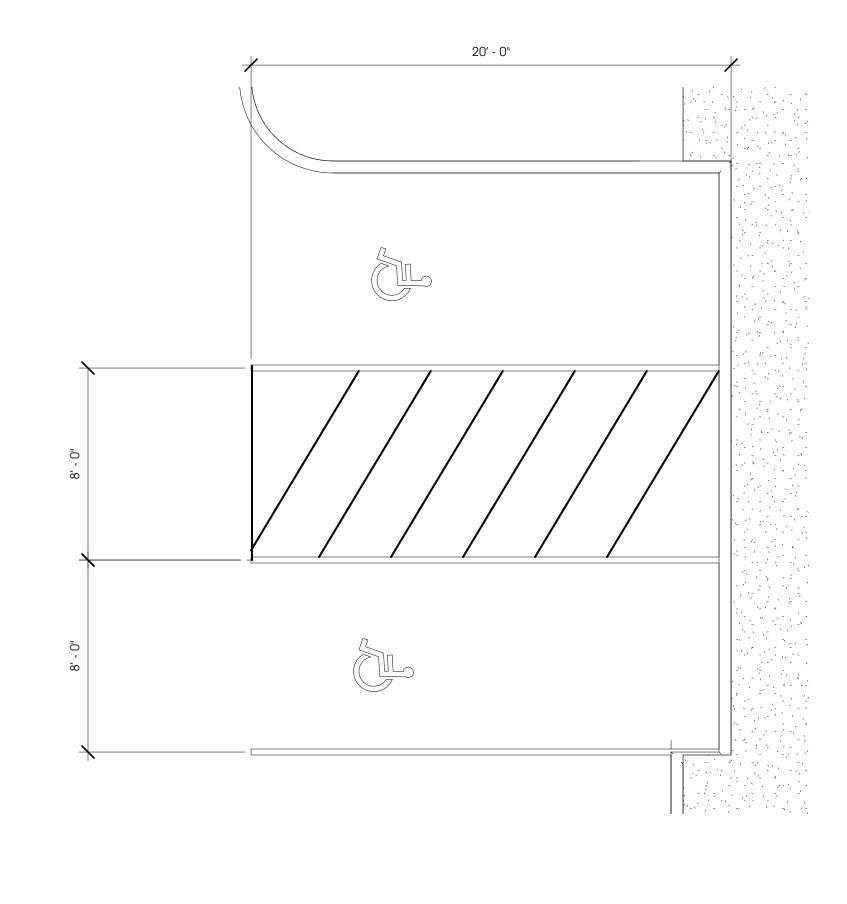


8 Typical ADA

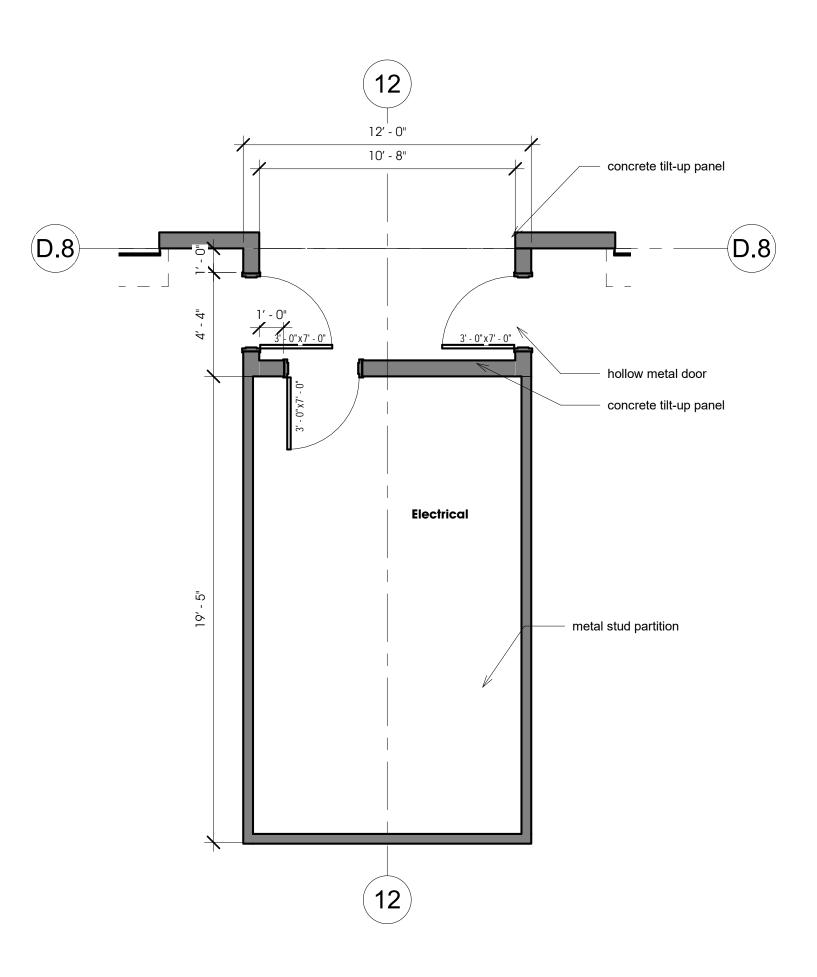


3 Typical -Electrical Room $1/4^{"} = 1'-0^{"}$

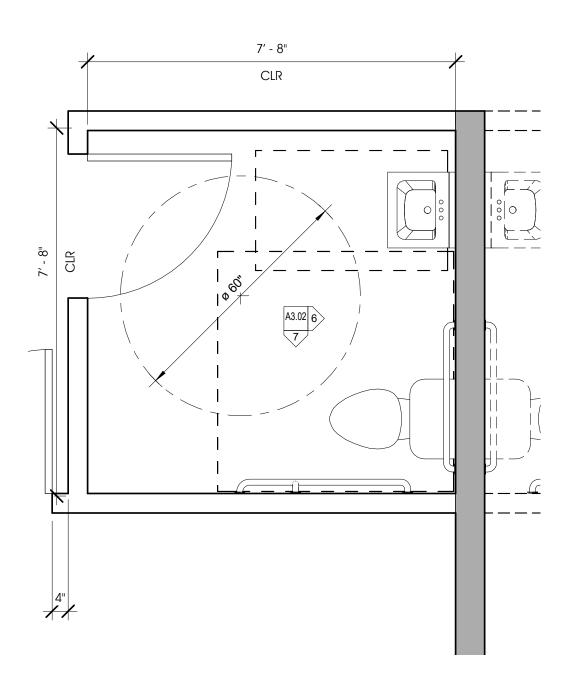




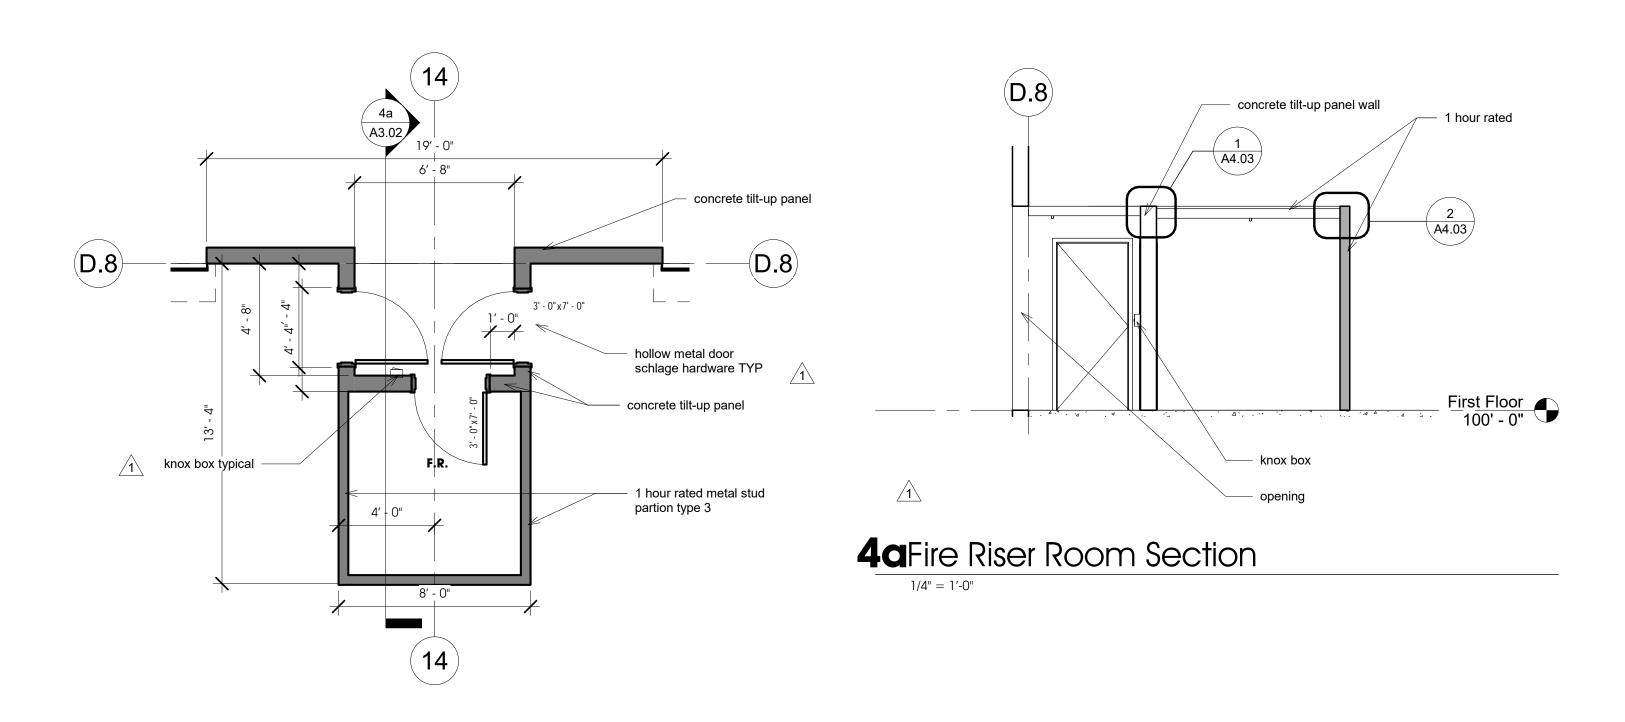

4 Typical- Fire Riser Room $\frac{1}{4''} = 1' \cdot 0''$

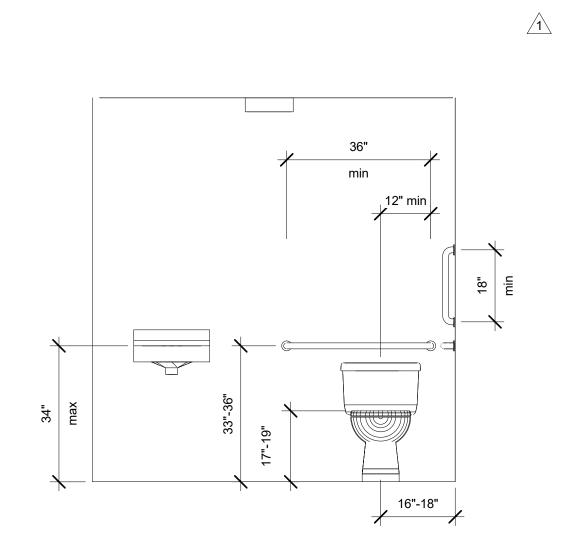



6 Bathroom 1 1/2" = 1'-0"

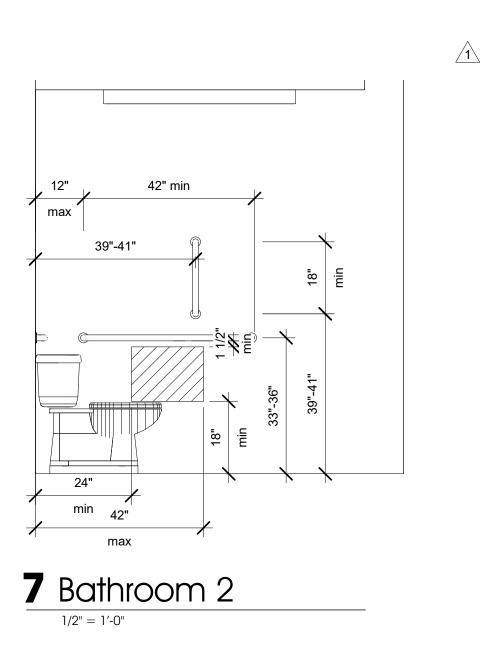





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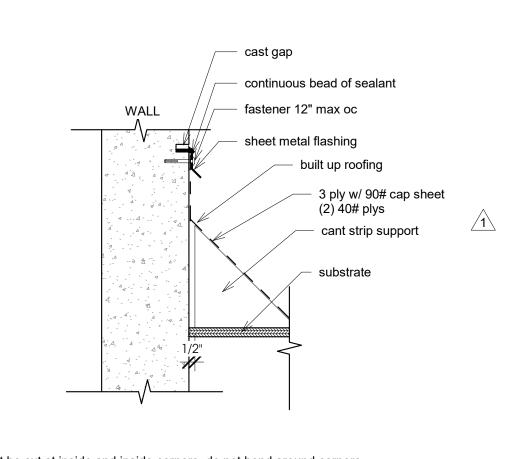


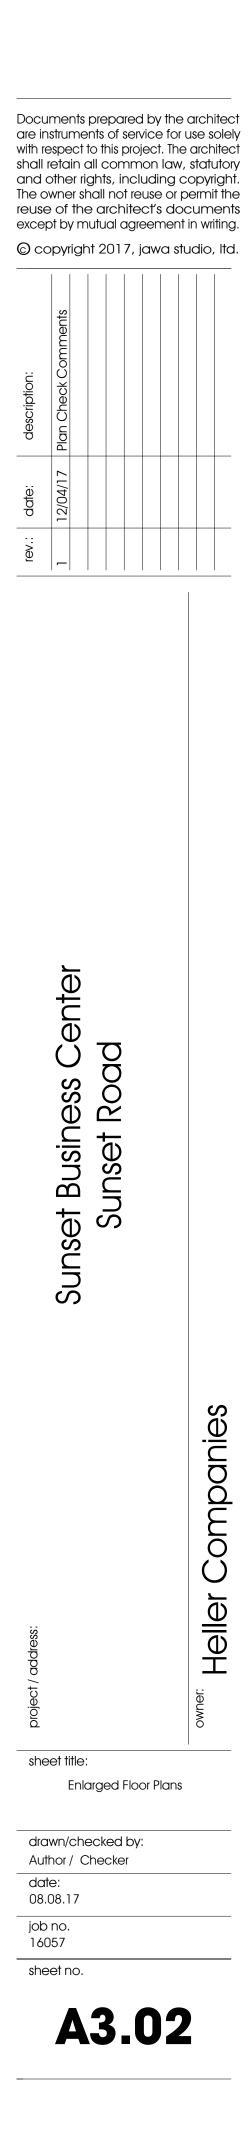

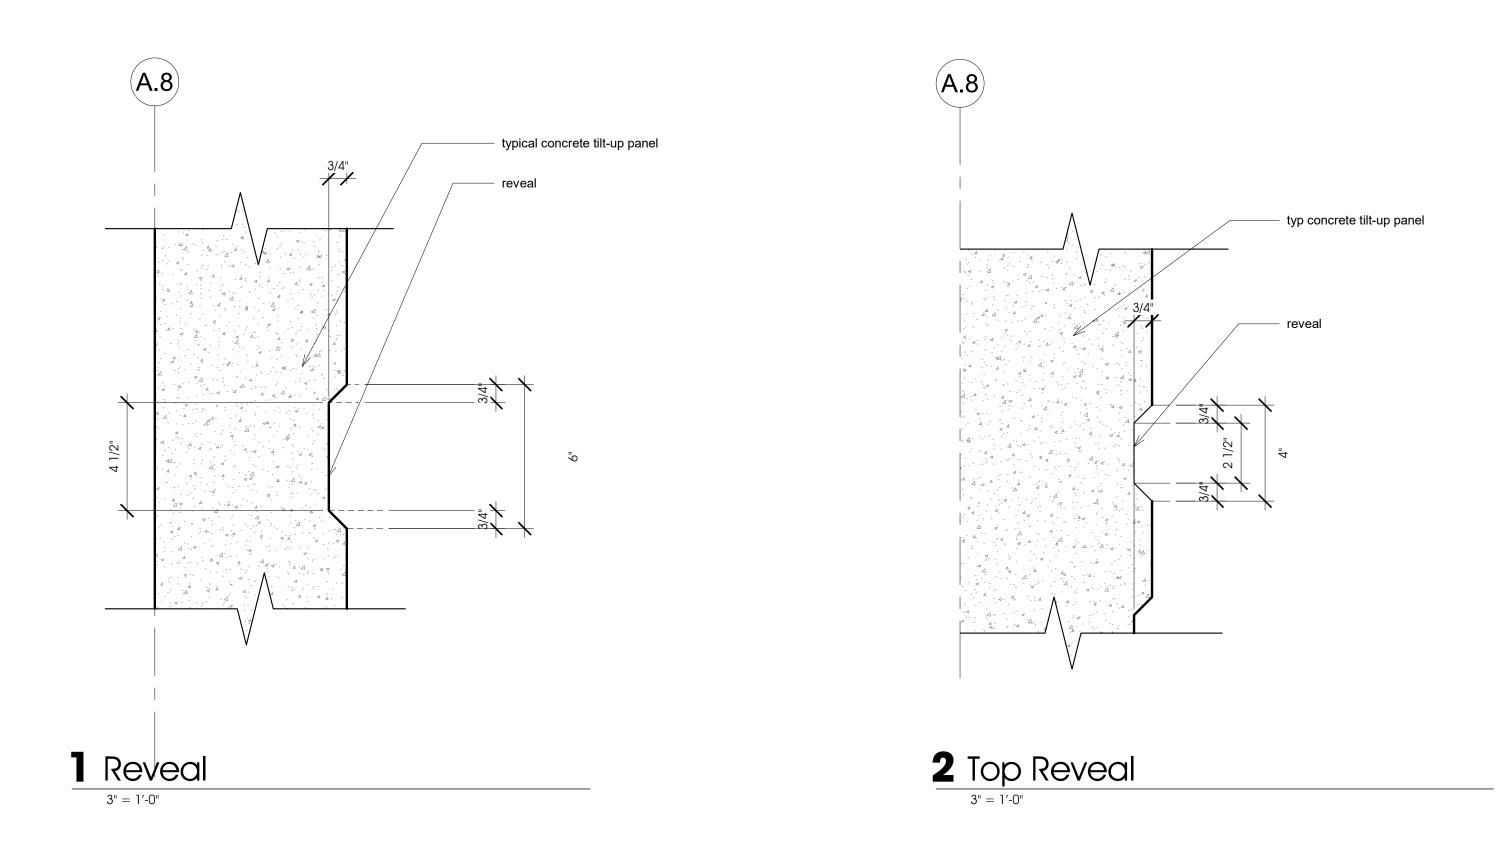

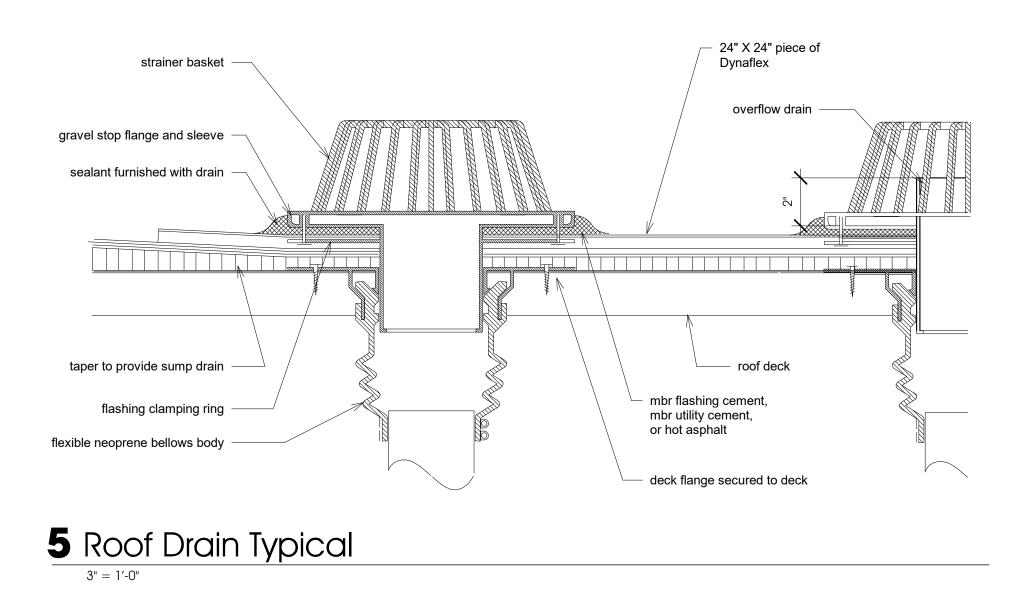

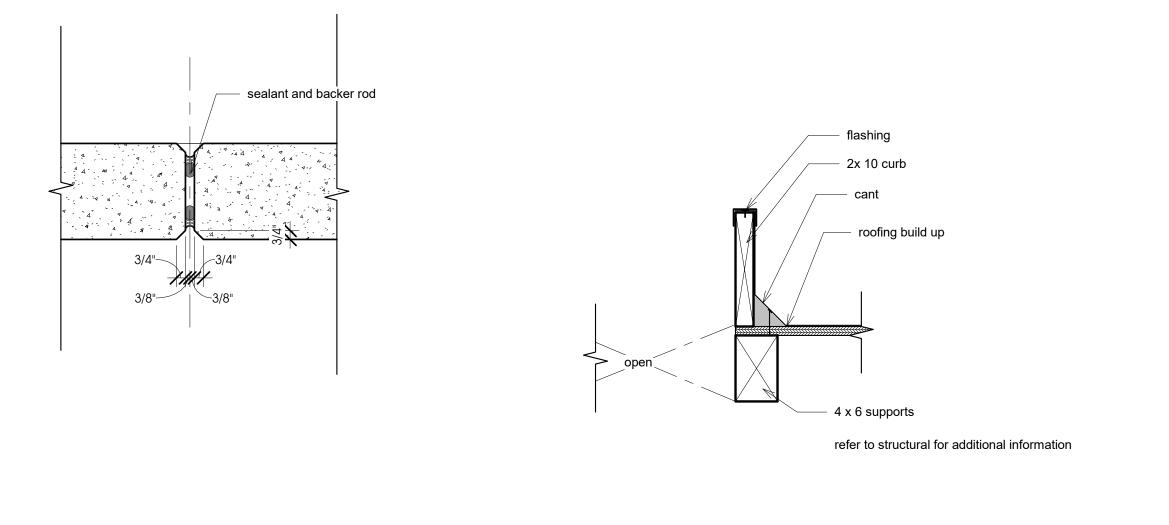
3 Panel Chamfer



notes:
1. flashing must be cut at inside and inside corners. do not bend around corners.
2. flashing must be fastened within 1" max. of all section ends.
3. bonding adhesive required between roofing and substrate for fully adhered systems.



4 Roof Curb

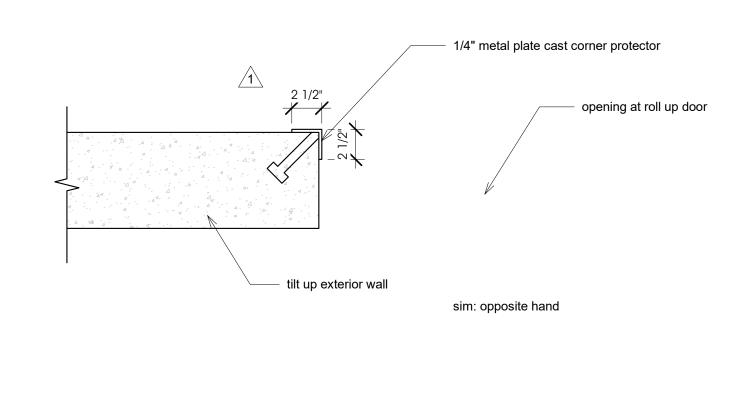







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seal:






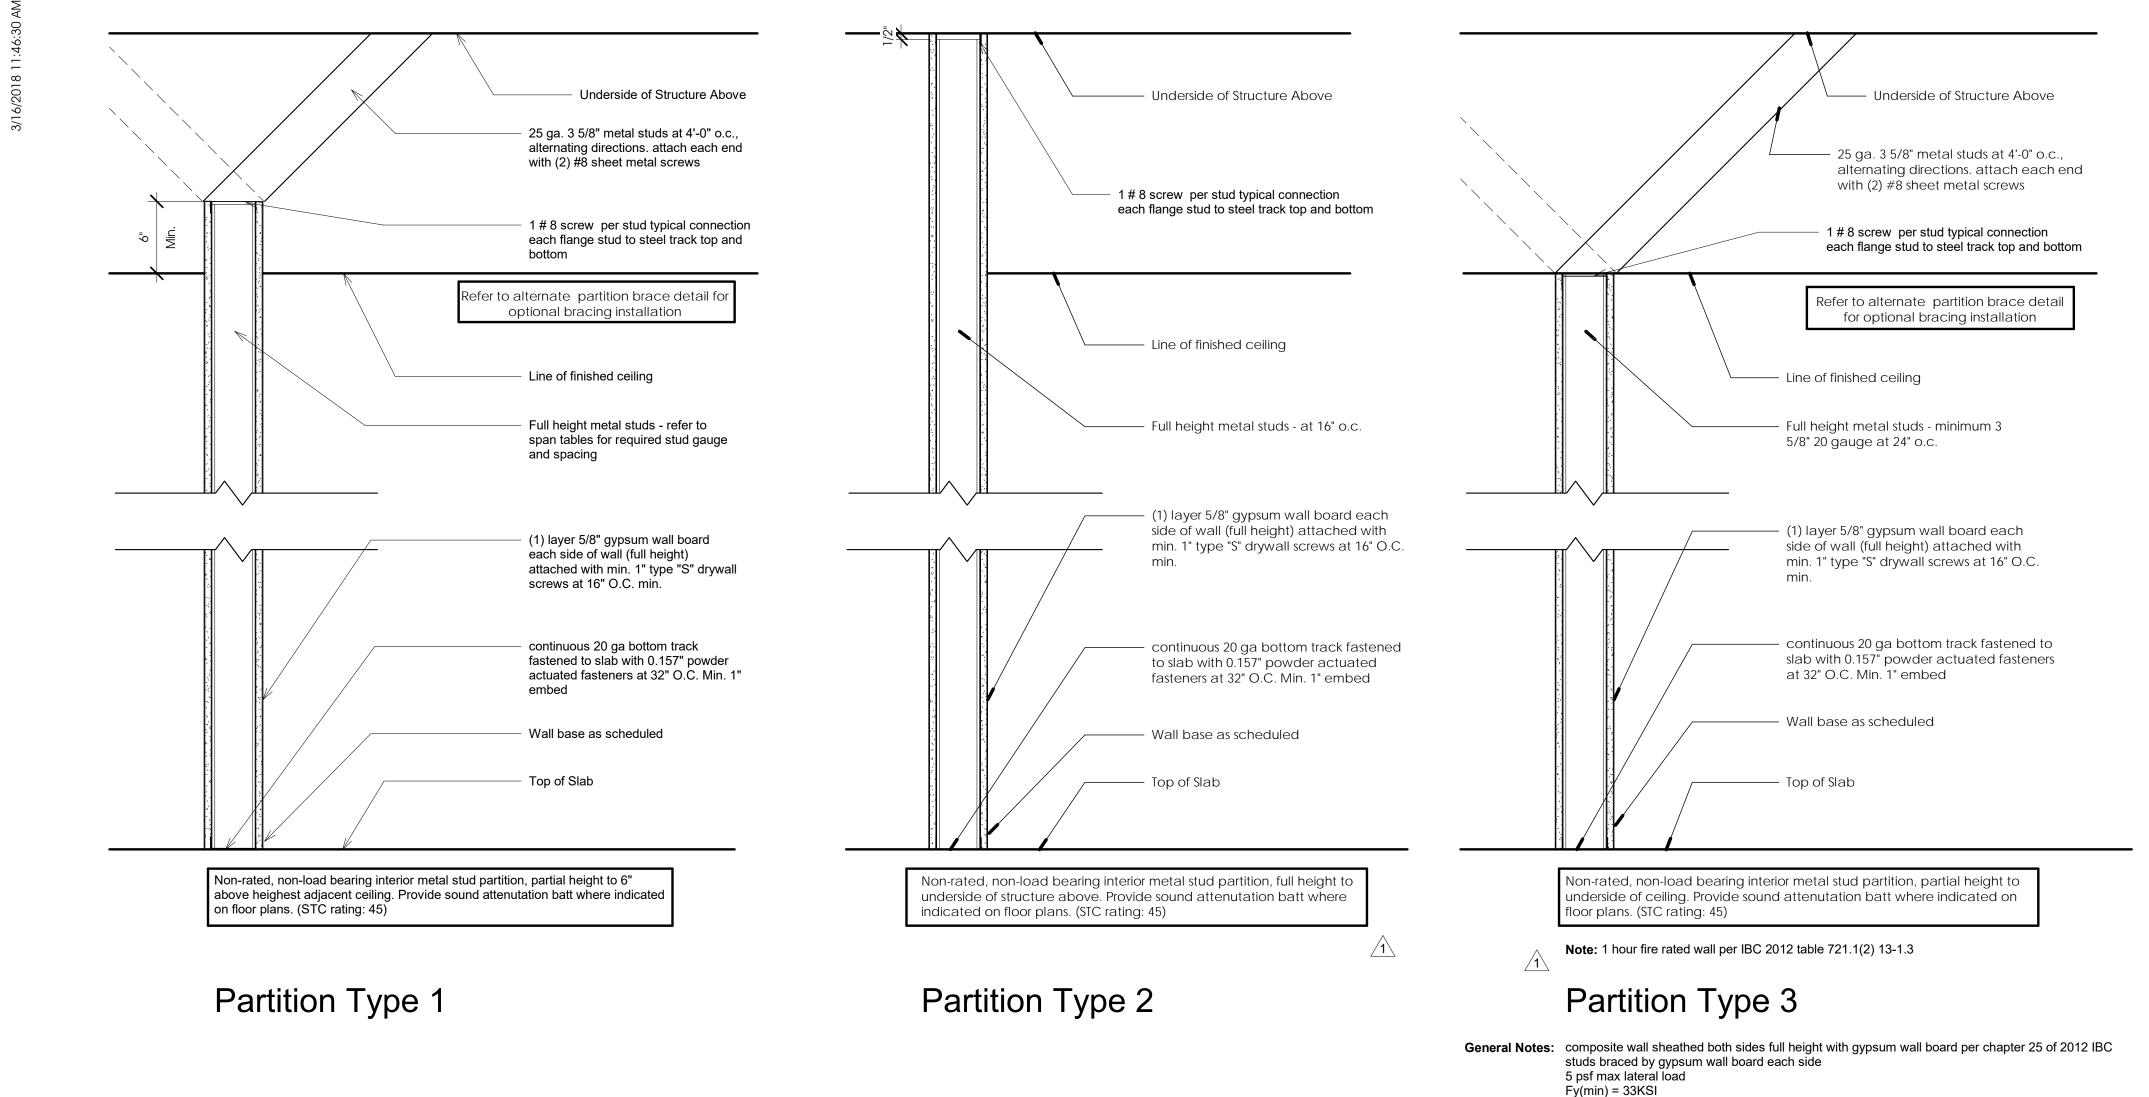

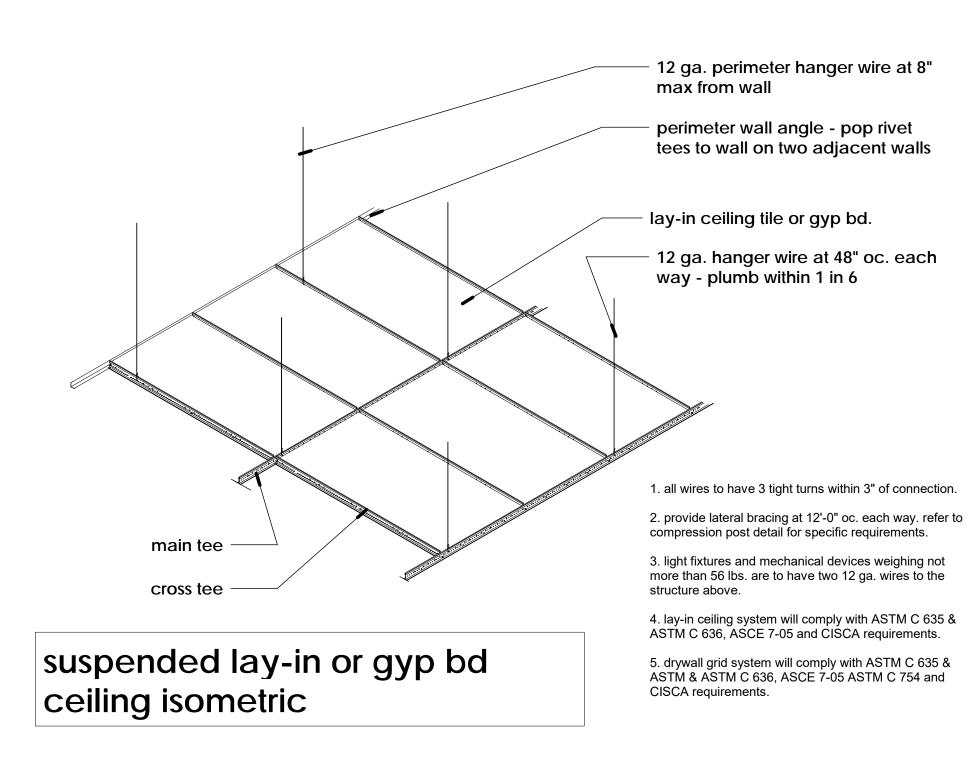


3 Typical Ceiling Details 1 3" = 1'-0"

L/120 deflection limit for height > 18'-0" and bracing >8'-0", submit engineering design and details.

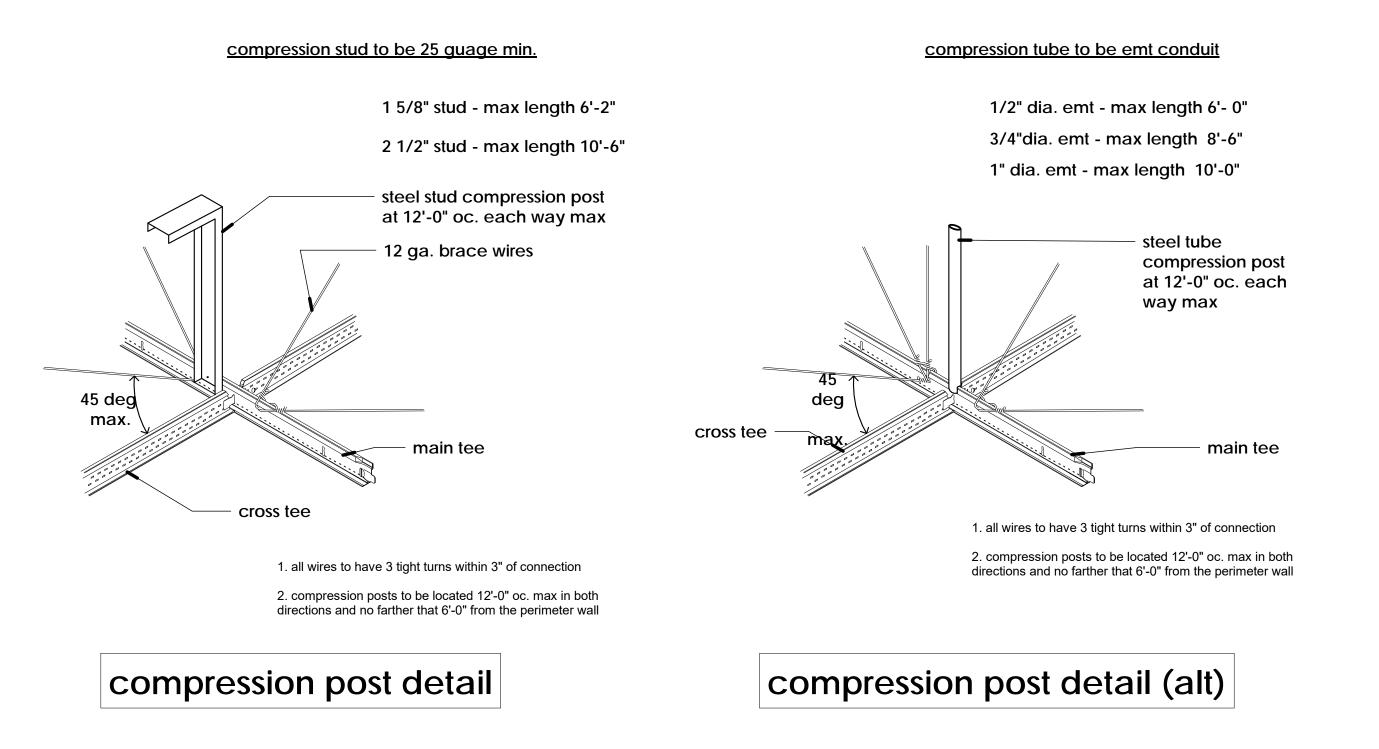

Metal Stud Height Chart

			101			ss stu	D (25	GAUGE)		
	Lateral Pressure = 5 PSF Lateral Pressure = 7.5 PSF Lateral Pressure =							= 10 PSI		
Stud Size	Deflection	Stud Spacing (O.C.)		Stud Spacing (O.C.)			Stud Spacing (O.C.)			
	Limit	24"	16"	12"	24"	16"	12"	24"	16"	12"
1 5/8"	L/120	9'-9"	10'-7"	11'-2"	8'-0"	8'-10"	9'-9"	N/A	8'-4"	8'-10
	L/240	N/A	8'-4"	8'-10"	N/A	N/A	N/A	N/A	N/A	N/A
	L/360	N/A	N/A	N/A	N/A	N/A	N/A	N/A	N/A	N/A
2 1/2"	L/120	11'-10"	13'-3"	15'-1"	9'-8"	10'-10"	12'-4"	8'-5"	9'-5"	10'-9
	L/240	10'-7"	11'-3"	11'-1"	9'-3"	9'-10"	10-'5"	N/A	N/A	N/A
	L/360	N/A	N/A	N/A	N/A	N/A	N/A	N/A	N/A	N/A
3 1/2"	L/120	13'-9"	15'-4"	17'-8"	11'-0"	12'-5"	14'-3"	9'-5"	10'-9"	12'-5
3 5/8"	L/240	13'-5"	14'-4"	15'-4"	11'-0"	12'-5"	13'-3"	9'-5"	10'-9"	12'-0
	L/360	11'-7"	12'-4"	13'-3"	10'-1"	10'-10"	11'-7"	9'-1"	9'-9"	10'-
4"	L/120	15'-1"	17'-2"	19'-6"	12'-1"	13'-10"	15'-9"	10'-5"	11'-11"	13'-8
	L/240	14'-2"	15'-4"	16'-5"	12'-1"	13'-4"	14'-4"	10'-5"	11'-11"	13'-8
	L/360	12'-4"	13'-4"	14'-4"	10'-9"	11'-8"	12'-6"	9'-9"	10'-6"	11'-4
6"	L/120	16'-9"	19'-9"	22'-10"	13'-5"	16'-2"	18'-7"	11'-5"	14'-0"	16'-2
Ũ	L/240	16'-9"	19'-9"	22'-1"	13'-5"	16'-2"	18'-7"	11'-5"	14'-0"	16'-2
	L/360	16'-9"	17'-11"	19'-4"	13'-5"	15'-7"	16'-9"	11'-5"	13'-10"	15'-0
	-,				12					
			20 1							
								GAUGE)		
	Deflection		Pressure			Pressure =			Pressure =	
Stud Size	Deflection Limit		Spacing (-		Spacing (Spacing (-
		24"	16"	12"	24"	16"	12"	24"	16"	12
1 5/8"	L/120	10'-5"	11'-6"	12'-5"	9'-2"	10'-1"	10'-10"	8'-3"	9'-2"	9'-1
	L/240	8'-3"	9'-2"	9'-11"	N/A	N/A	N/A	N/A	N/A	N/A
	L/360	N/A	N/A	N/A	N/A	N/A	N/A	N/A	N/A	N/A
2 1/2"	L/120	13'-9"	15'-4"	16'-8"	11'-11"	13'-4"	14'-7"	10'-9"	12'-1"	13'-2
	L/240	10'-9"	12'-1"	13'-2"	9'-4"	10'-6"	11'-6"	8'-6"	9'-6"	10'-3
	L/360	9'-4"	10'-6"	11'-6"	8'-1"	9'-2"	10'-0"	7'-4"	8'-4"	9'-1
3 1/2"	L/120	17'-9''	19'-11"	21'-8"	15'-6"	17'-5"	18'-1"	14'-10"	15'-8"	17'-1
3 5/8"	L/240	14'-0"	15'-8"	17'-11"	12'-0"	13'-7"	14'-10"	10'-10"	12'-3"	13'-
	L/360	12'-0"	13'-7"	14'-10"	10'-5"	11'-9"	12'-10"	9'-4"	10'-7"	11'-8
4"	L/120	19'-8"	22'-0"	24'-0"	17'-1"	19'-3"	20'-11"	14'-9"	17'-6"	19'-(
	L/240	15'-7"	17'-6"	19'-0"	13'-5"	15'-2"	16'-6"	12'-1"	13'-8"	14'-1
	L/360	13'-5"	15'-2"	16'-6"	11'-7"	13'-1"	14'-4"	10'-5"	11'-10"	12'-1
6"	L/120	25'-1"	29'-2"	32'-1"	20'-6"	24'-9"	28'-0"	17'-9"	21'-5"	24'-7
	L/240	20'-3"	23'-2"	25'-6'"	17'-8"	20'-3"	22'-3"	16'-0"	18'-4"	20'-3
	L/360	17'-8"	20'-3"	22'-3"	15'-5"	17'-8"	19'-5"	13'-8"	15'-10"	17'-6
			33 N	AIL TH	ICKNE	SS STU	D (20)	GAUGE)		
					_		<u>`</u>	,	Pressure =	= 10 PS
		Latera	Pressure	= 5 PSF	Lateral	Pressure =	7.5 PSF		11000010	
Stud Size	Deflection			= 5 PSF O.C.)	Lateral Stud			Stud	Spacina (
Stud Size	Deflection Limit		Pressure Spacing (16"			Pressure = Spacing (16"		Stud 24"	Spacing (16"	-
Stud Size 1 5/8"		Stud	Spacing (0.C.)	Stud	Spacing (0.C.)			12
	Limit	Stud 24"	Spacing (16"	0.C.) 12"	Stud 24" 9'-7"	Spacing (16"	0.C.) 12"	24" 8'-9"	16" 9'-8"	12' 10'-4
	Limit L/120	Stud 24" 11'-1"	Spacing (16" 12'-1"	O.C.) 12" 13'-0"	Stud 24''	Spacing (16" 10'-7"	O.C.) 12" 11'-4"	24"	16"	12' 10'-4 N/4
1 5/8"	Limit L/120 L/240 L/360	Stud 24" 11'-1" 8'-9" 8'-9"	Spacing (16" 12'-1" 9'-8" 9'-8"	0.C.) 12" 13'-0" 10'-4"	Stud 24" 9'-7" 7'-8"	Spacing (16" 10'-7" 8'-5"	0.C.) 12" 11'-4" 9'-0" N/A	24" 8'-9" N/A N/A	16" 9'-8" N/A N/A	12' 10'-4 N/4 N/4
	Limit L/120 L/240 L/360 L/120	Stud 24" 11'-1" 8'-9"	Spacing (16" 12'-1" 9'-8" 9'-8" 16'-5"	O.C.) 12" 13'-0" 10'-4" 10'-4" 17'-9"	Stud 24" 9'-7" 7'-8" N/A 13'-0"	Spacing (16" 10'-7" 8'-5" N/A	0.C.) 12" 11'-4" 9'-0"	24" 8'-9" N/A	16" 9'-8" N/A	12' 10'-4 N/4 N/4 13'-1
1 5/8"	Limit L/120 L/240 L/360	Stud 24" 11'-1" 8'-9" 8'-9" 14'-10"	Spacing (16" 12'-1" 9'-8" 9'-8"	O.C.) 12" 13'-0" 10'-4" 10'-4"	Stud 24" 9'-7" 7'-8" N/A 13'-0" 10'-0"	Spacing (16" 10'-7" 8'-5" N/A 14'-4"	O.C.) 12" 11'-4" 9'-0" N/A 15'-6"	24" 8'-9" N/A N/A 11'-7"	16" 9'-8" N/A N/A 12'-11" 10'-0"	12' 10'-4 N/4 13'-1 10'-1
1 5/8" 2 1/2"	Limit L/120 L/240 L/360 L/120 L/240 L/240 L/360	Stud 24" 11'-1" 8'-9" 8'-9" 14'-10" 11'-7" 10'-0"	Spacing (16" 12'-1" 9'-8" 9'-8" 16'-5" 12'-10" 11'-2"	O.C.) 12" 13'-0" 10'-4" 10'-4" 10'-4" 15'-11" 12'-1"	Stud 24" 9'-7" 7'-8" N/A 13'-0" 10'-0" 8'-7"	Spacing (16" 10'-7" 8'-5" N/A 14'-4" 11'-2" 9'-8"	O.C.) 12" 11'-4" 9'-0" N/A 15'-6" 12'-1" 10'-6"	24" 8'-9" N/A N/A 11'-7" 8'-11" 7'-5"	16" 9'-8" N/A N/A 12'-11" 10'-0" 8'-8"	12' 10'-4 N/4 13'-1 10'-1 9'-5
1 5/8" 2 1/2" 3 1/2"	Limit L/120 L/240 L/360 L/120 L/240 L/360 L/120	Stud 24" 11'-1" 8'-9" 14'-10" 11'-7" 10'-0" 18'-6"	Spacing (16" 12'-1" 9'-8" 9'-8" 16'-5" 12'-10" 11'-2" 20'-8"	O.C.) 12" 13'-0" 10'-4" 10'-4" 17'-9" 15'-11" 12'-1" 22'-6"	Stud 24" 9'-7" 7'-8" N/A 13'-0" 10'-0" 8'-7" 16'-2"	Spacing (16" 10'-7" 8'-5" N/A 14'-4" 11'-2" 9'-8" 18'-1"	O.C.) 12" 11'-4" 9'-0" N/A 15'-6" 12'-1" 10'-6" 19'-8"	24" 8'-9" N/A N/A 11'-7" 8'-11" 7'-5" 14'-9"	16" 9'-8" N/A N/A 12'-11" 10'-0" 8'-8" 16'-5"	12' 10'-4 N/4 13'-1 10'-1 9'-5 17'-1
1 5/8" 2 1/2"	Limit L/120 L/240 L/360 L/120 L/240 L/360 L/120 L/120 L/240	Stud 24" 11'-1" 8'-9" 8'-9" 14'-10" 11'-7" 10'-0" 18'-6" 14'-9"	Spacing (16" 12'-1" 9'-8" 9'-8" 16'-5" 12'-10" 11'-2" 20'-8" 16'-5"	O.C.) 12" 13'-0" 10'-4" 10'-4" 17'-9" 15'-11" 12'-1" 22'-6" 17'-10"	Stud 24" 9'-7" 7'-8" N/A 13'-0" 10'-0" 8'-7" 16'-2" 16'-2"	Spacing (16" 10'-7" 8'-5" N/A 14'-4" 11'-2" 9'-8" 18'-1" 14'-3"	O.C.) 12" 11'-4" 9'-0" N/A 15'-6" 12'-1" 10'-6" 19'-8" 15'-6"	24" 8'-9" N/A N/A 11'-7" 8'-11" 7'-5" 14'-9" 11'-7"	16" 9'-8" N/A N/A 12'-11" 10'-0" 8'-8" 16'-5" 12'-11"	12' 10'-4 N/4 13'-1 10'-1 9'-5 17'-1 14'-
1 5/8" 2 1/2" 3 1/2" 3 5/8"	Limit L/120 L/240 L/360 L/120 L/240 L/360 L/120 L/240 L/240 L/260	Stud 24" 11'-1" 8'-9" 8'-9" 14'-10" 11'-7" 10'-0" 18'-6" 18'-6" 14'-9" 12'-9"	Spacing (16" 12'-1" 9'-8" 9'-8" 16'-5" 12'-10" 11'-2" 20'-8" 16'-5" 14'-3"	O.C.) 12" 13'-0" 10'-4" 10'-4" 17'-9" 15'-11" 12'-1" 22'-6" 17'-10" 15'-6"	Stud 24" 9'-7" 7'-8" N/A 13'-0" 10'-0" 8'-7" 16'-2" 12'-9" 11'-2"	Spacing (16" 10'-7" 8'-5" N/A 14'-4" 11'-2" 9'-8" 18'-1" 14'-3" 12'-6"	O.C.) 12" 11'-4" 9'-0" N/A 15'-6" 12'-1" 10'-6" 19'-8" 15'-6" 13'-7"	24" 8'-9" N/A N/A 11'-7" 8'-11" 7'-5" 14'-9" 11'-7" 10'-1"	16" 9'-8" N/A N/A 12'-11" 10'-0" 8'-8" 16'-5" 12'-11" 11'-4"	12' 10'-4 N/4 13'-1 10'-1 9'-5 17'-1 14'- 12'-4
1 5/8" 2 1/2" 3 1/2"	Limit L/120 L/240 L/360 L/120 L/240 L/360 L/120 L/240 L/360 L/120	Stud 24" 11'-1" 8'-9" 14'-10" 14'-10" 11'-7" 10'-0" 18'-6" 14'-9" 12'-9" 20'-9"	Spacing (16" 12'-1" 9'-8" 9'-8" 16'-5" 12'-10" 11'-2" 20'-8" 16'-5" 14'-3" 23'-1"	O.C.) 12" 13'-0" 10'-4" 10'-4" 17'-9" 15'-11" 12'-1" 22'-6" 17'-10" 15'-6" 25'-1"	Stud 24" 9'-7" 7'-8" N/A 13'-0" 10'-0" 8'-7" 16'-2" 12'-9" 11'-2" 18'-1"	Spacing (16" 10'-7" 8'-5" N/A 14'-4" 11'-2" 9'-8" 18'-1" 14'-3" 12'-6" 20'-2"	O.C.) 12" 11'-4" 9'-0" N/A 15'-6" 12'-1" 10'-6" 19'-8" 15'-6" 13'-7" 21'-11"	24" 8'-9" N/A N/A 11'-7" 8'-11" 7'-5" 14'-9" 11'-7" 10'-1" 16'-5"	16" 9'-8" N/A N/A 12'-11" 10'-0" 8'-8" 16'-5" 12'-11" 11'-4" 18'-4"	12'' 10'-4 N/A 13'-1 10'-1 9'-5 17'-1 14'-1 12'-4 19'-1
1 5/8" 2 1/2" 3 1/2" 3 5/8"	Limit L/120 L/240 L/360 L/120 L/240 L/360 L/120 L/240 L/360 L/120 L/240	Stud 24" 11'-1" 8'-9" 14'-10" 11'-7" 10'-0" 18'-6" 14'-9" 12'-9" 20'-9" 16'-5"	Spacing (16" 12'-1" 9'-8" 9'-8" 16'-5" 12'-10" 11'-2" 20'-8" 16'-5" 16'-5" 14'-3" 23'-1" 18'-4"	O.C.) 12" 13'-0" 10'-4" 10'-4" 17'-9" 15'-11" 12'-1" 22'-6" 17'-10" 15'-6" 25'-1" 19'-11"	Stud 24" 9'-7" 7'-8" N/A 13'-0" 10'-0" 8'-7" 16'-2" 16'-2" 12'-9" 11'-2" 18'-1" 18'-1"	Spacing (16" 10'-7" 8'-5" N/A 14'-4" 11'-2" 9'-8" 18'-1" 14'-3" 12'-6" 20'-2" 15'-11"	O.C.) 12" 11'-4" 9'-0" N/A 15'-6" 12'-1" 10'-6" 19'-8" 15'-6" 13'-7" 21'-11" 17'-4"	24" 8'-9" N/A N/A 11'-7" 8'-11" 7'-5" 14'-9" 11'-7" 10'-1" 16'-5" 12'-10"	16" 9'-8" N/A N/A 12'-11" 10'-0" 8'-8" 16'-5" 12'-11" 11'-4" 18'-4" 14'-5"	12' 10'-4 N/A 13'-1 10'-1 9'-5 17'-1 14'- 12'-4 19'-1 15'-8
1 5/8" 2 1/2" 3 1/2" 3 5/8" 4"	Limit L/120 L/240 L/360 L/120 L/240 L/360 L/120 L/240 L/360 L/120 L/240 L/240	Stud 24" 11'-1" 8'-9" 14'-10" 11'-7" 10'-0" 18'-6" 14'-9" 20'-9" 16'-5" 14'-3"	Spacing (16" 12'-1" 9'-8" 9'-8" 16'-5" 12'-10" 11'-2" 20'-8" 16'-5" 14'-3" 23'-1" 18'-4" 15'-11"	O.C.) 12" 13'-0" 10'-4" 10'-4" 17'-9" 15'-11" 12'-1" 22'-6" 17'-10" 15'-6" 25'-1" 19'-11" 17'-4"	Stud 24" 9'-7" 7'-8" N/A 13'-0" 10'-0" 8'-7" 16'-2" 16'-2" 12'-9" 11'-2" 18'-1" 14'-3" 12'-4"	Spacing (16" 10'-7" 8'-5" N/A 14'-4" 11'-2" 9'-8" 18'-1" 14'-3" 14'-3" 14'-3" 12'-6" 20'-2" 15'-11" 13'-9"	O.C.) 12" 11'-4" 9'-0" N/A 15'-6" 12'-1" 10'-6" 19'-8" 15'-6" 13'-7" 21'-11" 17'-4" 15'-0"	24" 8'-9" N/A N/A 11'-7" 8'-11" 7'-5" 14'-9" 11'-7" 10'-1" 16'-5" 12'-10" N/A	16" 9'-8" N/A N/A 12'-11" 10'-0" 8'-8" 16'-5" 12'-11" 11'-4" 18'-4" 14'-5" N/A	12' 10'-4 N/A 13'-1 10'-1 9'-5 17'-1 14'- 12'-4 19'-1 15'-8 N/A
2 1/2" 3 1/2" 3 5/8"	Limit L/120 L/240 L/360 L/120 L/240 L/360 L/120 L/240 L/360 L/120 L/240	Stud 24" 11'-1" 8'-9" 14'-10" 11'-7" 10'-0" 18'-6" 14'-9" 12'-9" 20'-9" 16'-5"	Spacing (16" 12'-1" 9'-8" 9'-8" 16'-5" 12'-10" 11'-2" 20'-8" 16'-5" 16'-5" 14'-3" 23'-1" 18'-4"	O.C.) 12" 13'-0" 10'-4" 10'-4" 17'-9" 15'-11" 12'-1" 22'-6" 17'-10" 15'-6" 25'-1" 19'-11"	Stud 24" 9'-7" 7'-8" N/A 13'-0" 10'-0" 8'-7" 16'-2" 16'-2" 12'-9" 11'-2" 18'-1" 18'-1"	Spacing (16" 10'-7" 8'-5" N/A 14'-4" 11'-2" 9'-8" 18'-1" 14'-3" 12'-6" 20'-2" 15'-11"	O.C.) 12" 11'-4" 9'-0" N/A 15'-6" 12'-1" 10'-6" 19'-8" 15'-6" 13'-7" 21'-11" 17'-4"	24" 8'-9" N/A N/A 11'-7" 8'-11" 7'-5" 14'-9" 11'-7" 10'-1" 16'-5" 12'-10"	16" 9'-8" N/A N/A 12'-11" 10'-0" 8'-8" 16'-5" 12'-11" 11'-4" 18'-4" 14'-5"	12" 10'-4 N/A 13'-1 10'-1 9'-5 17'-1 14'-1 12'-4 19'-1 15'-8 N/A 25'-9 21'-3

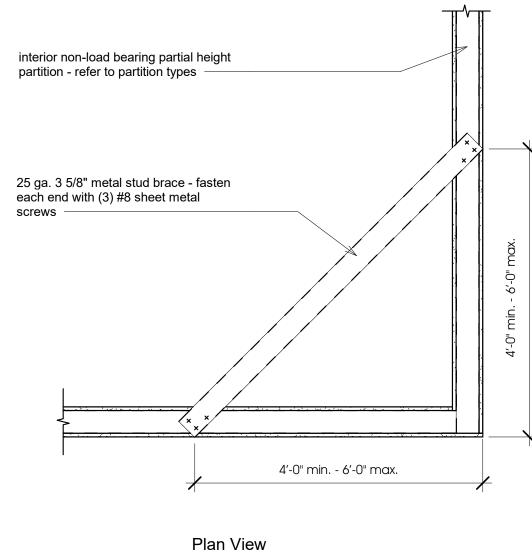


2 Alternate Partition Brace1


3/4" = 1'-0"




Las Vegas NV 89104 tel. 702.598.1723 fax. 702.598.1724 mail@jawastudio com consultant:

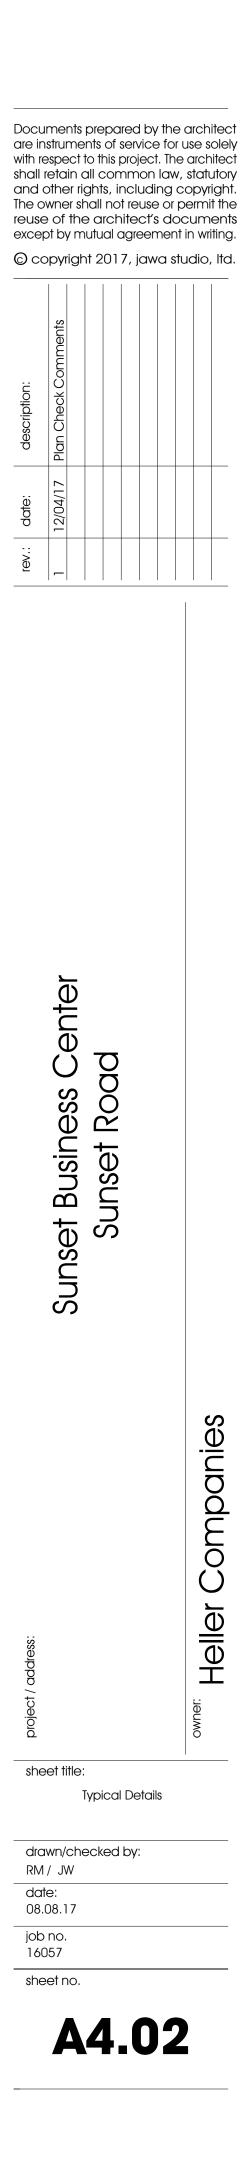

<u>/1</u>

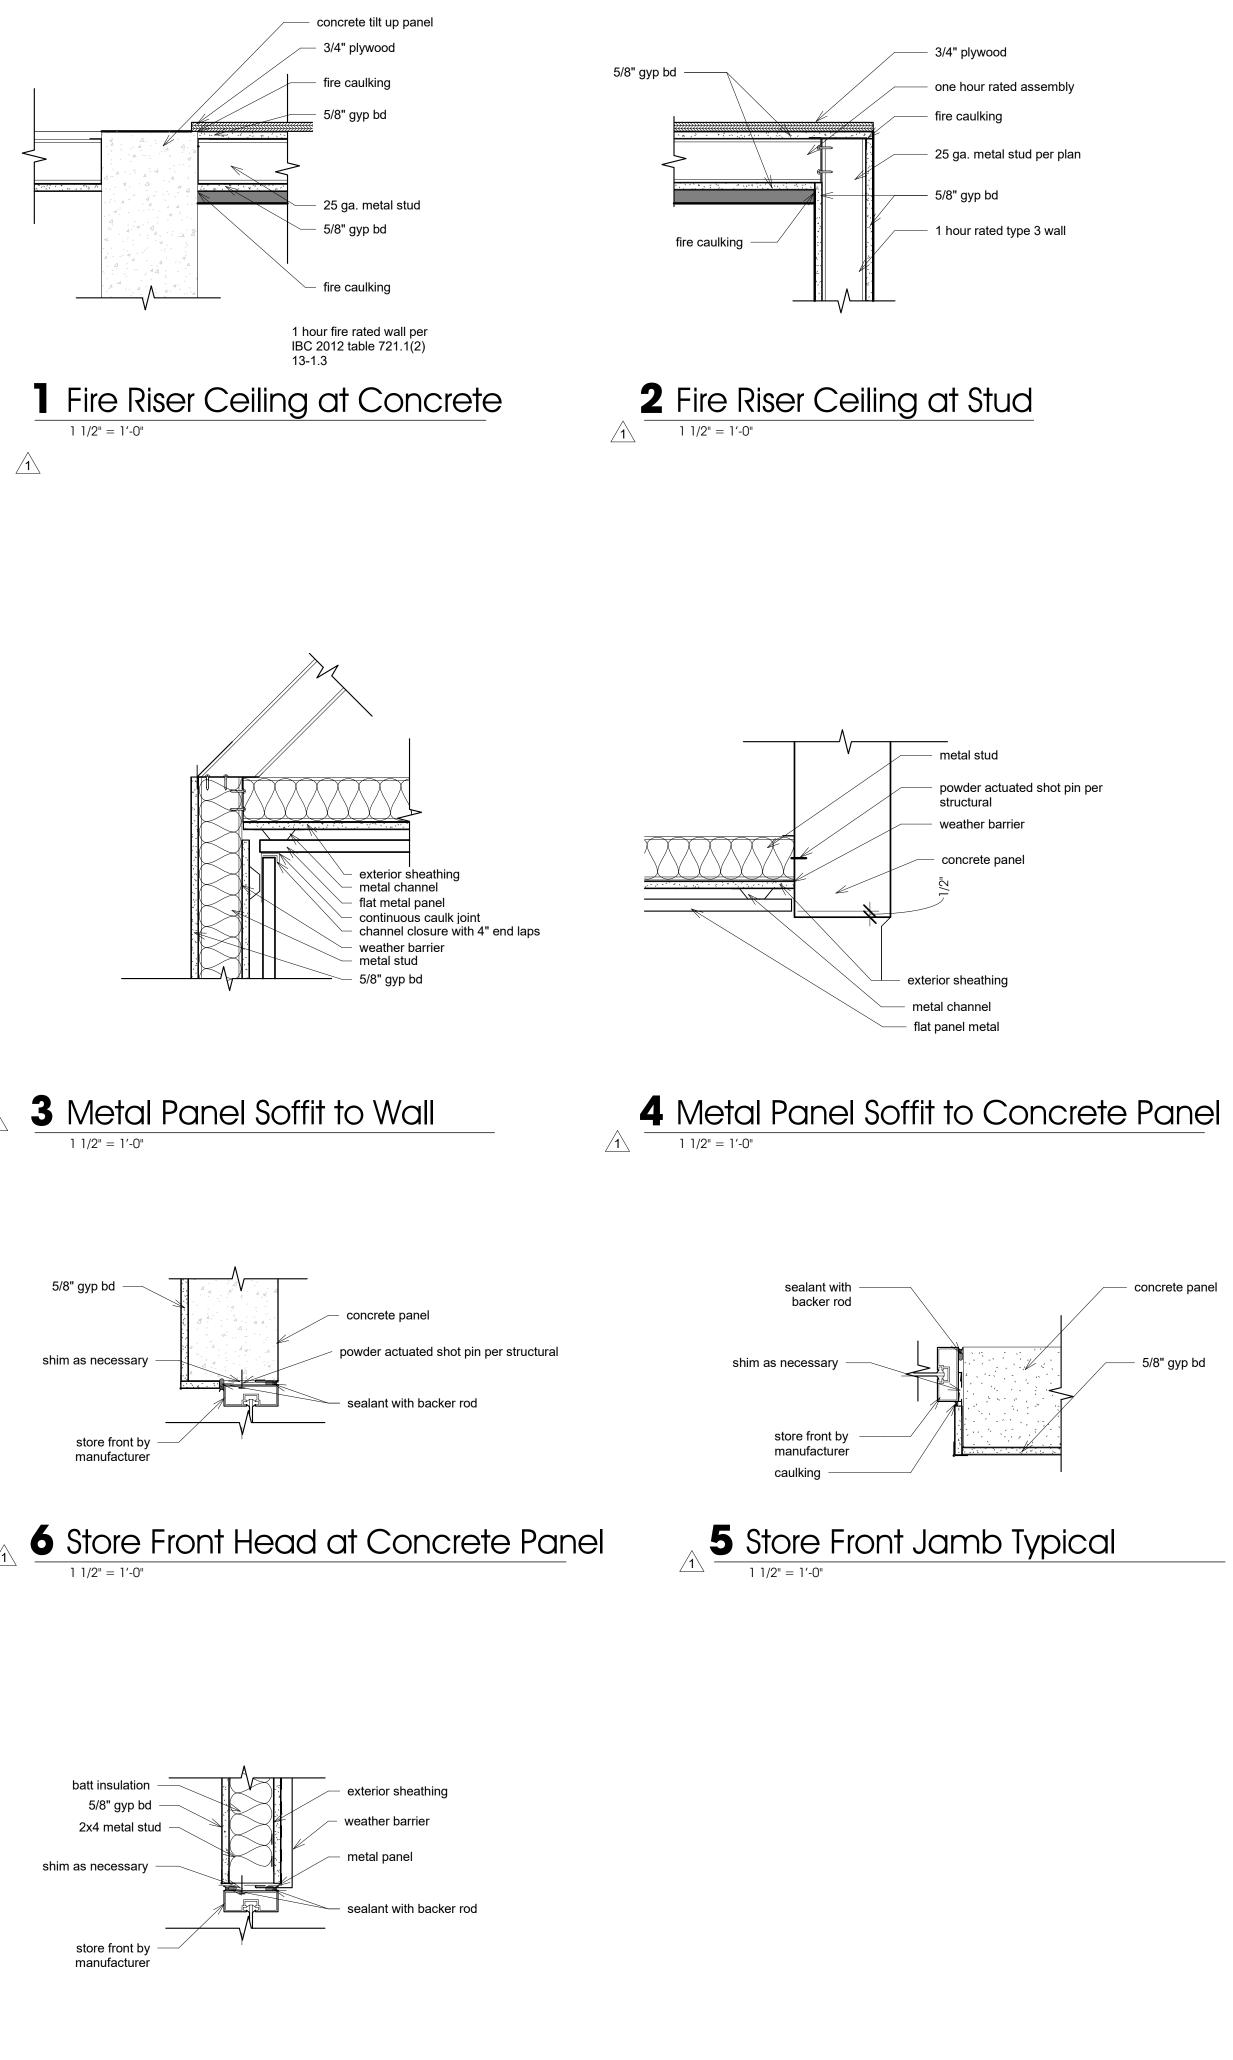

7 Store Front Head at Metal Stud 1 1/2" = 1'-0"

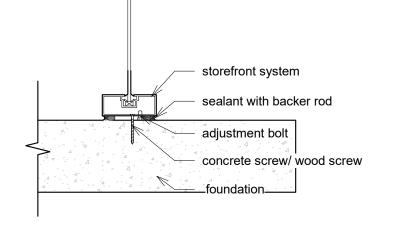


▲ 8 Store Front Sill 1 1/2" = 1'-0"




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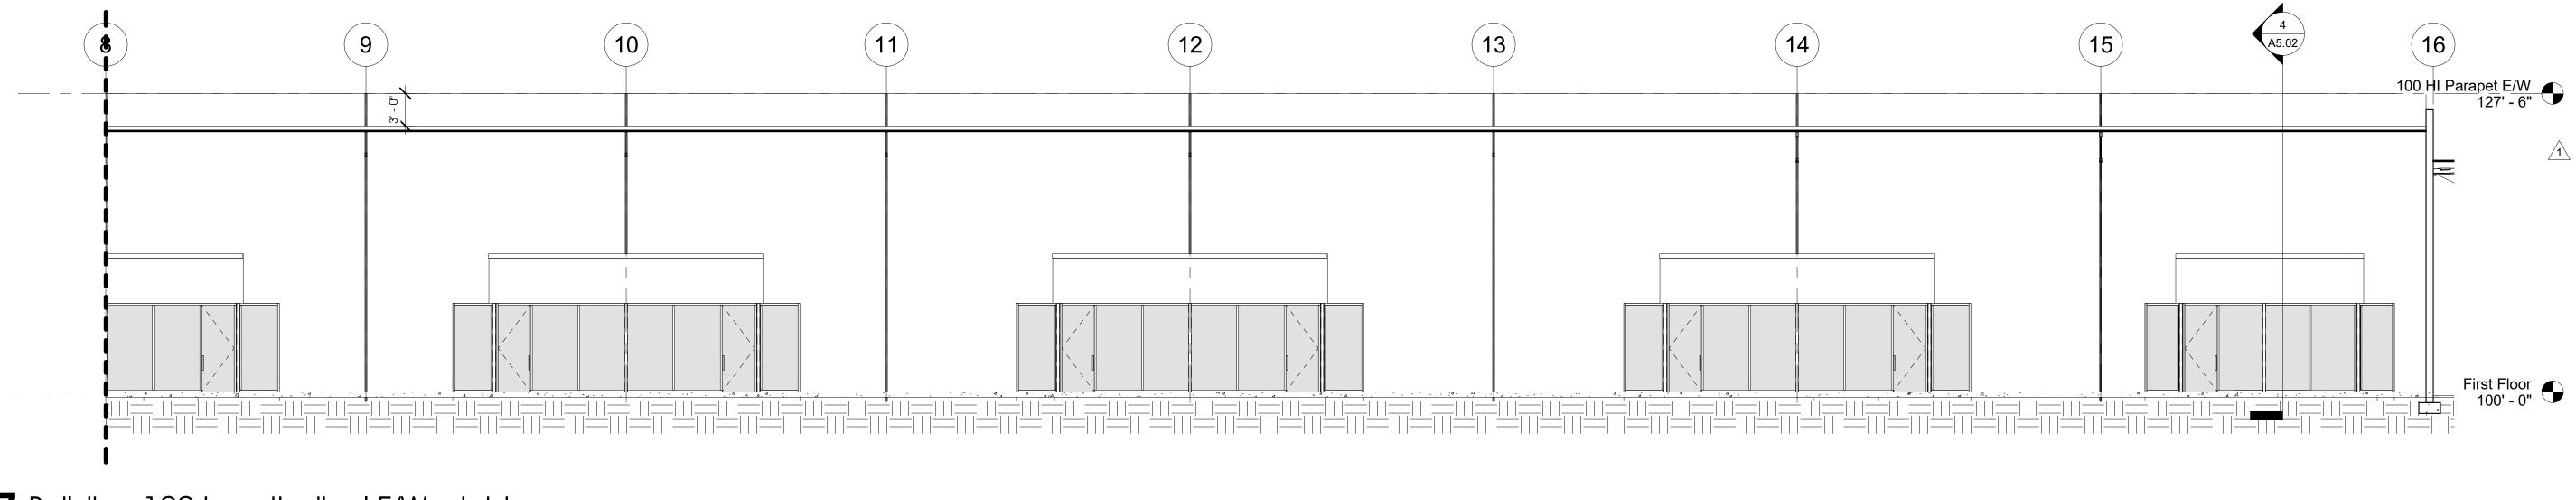
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6 Building 100 Longitudinal E/W - left



7 Building 100 Longitudinal E/W - right

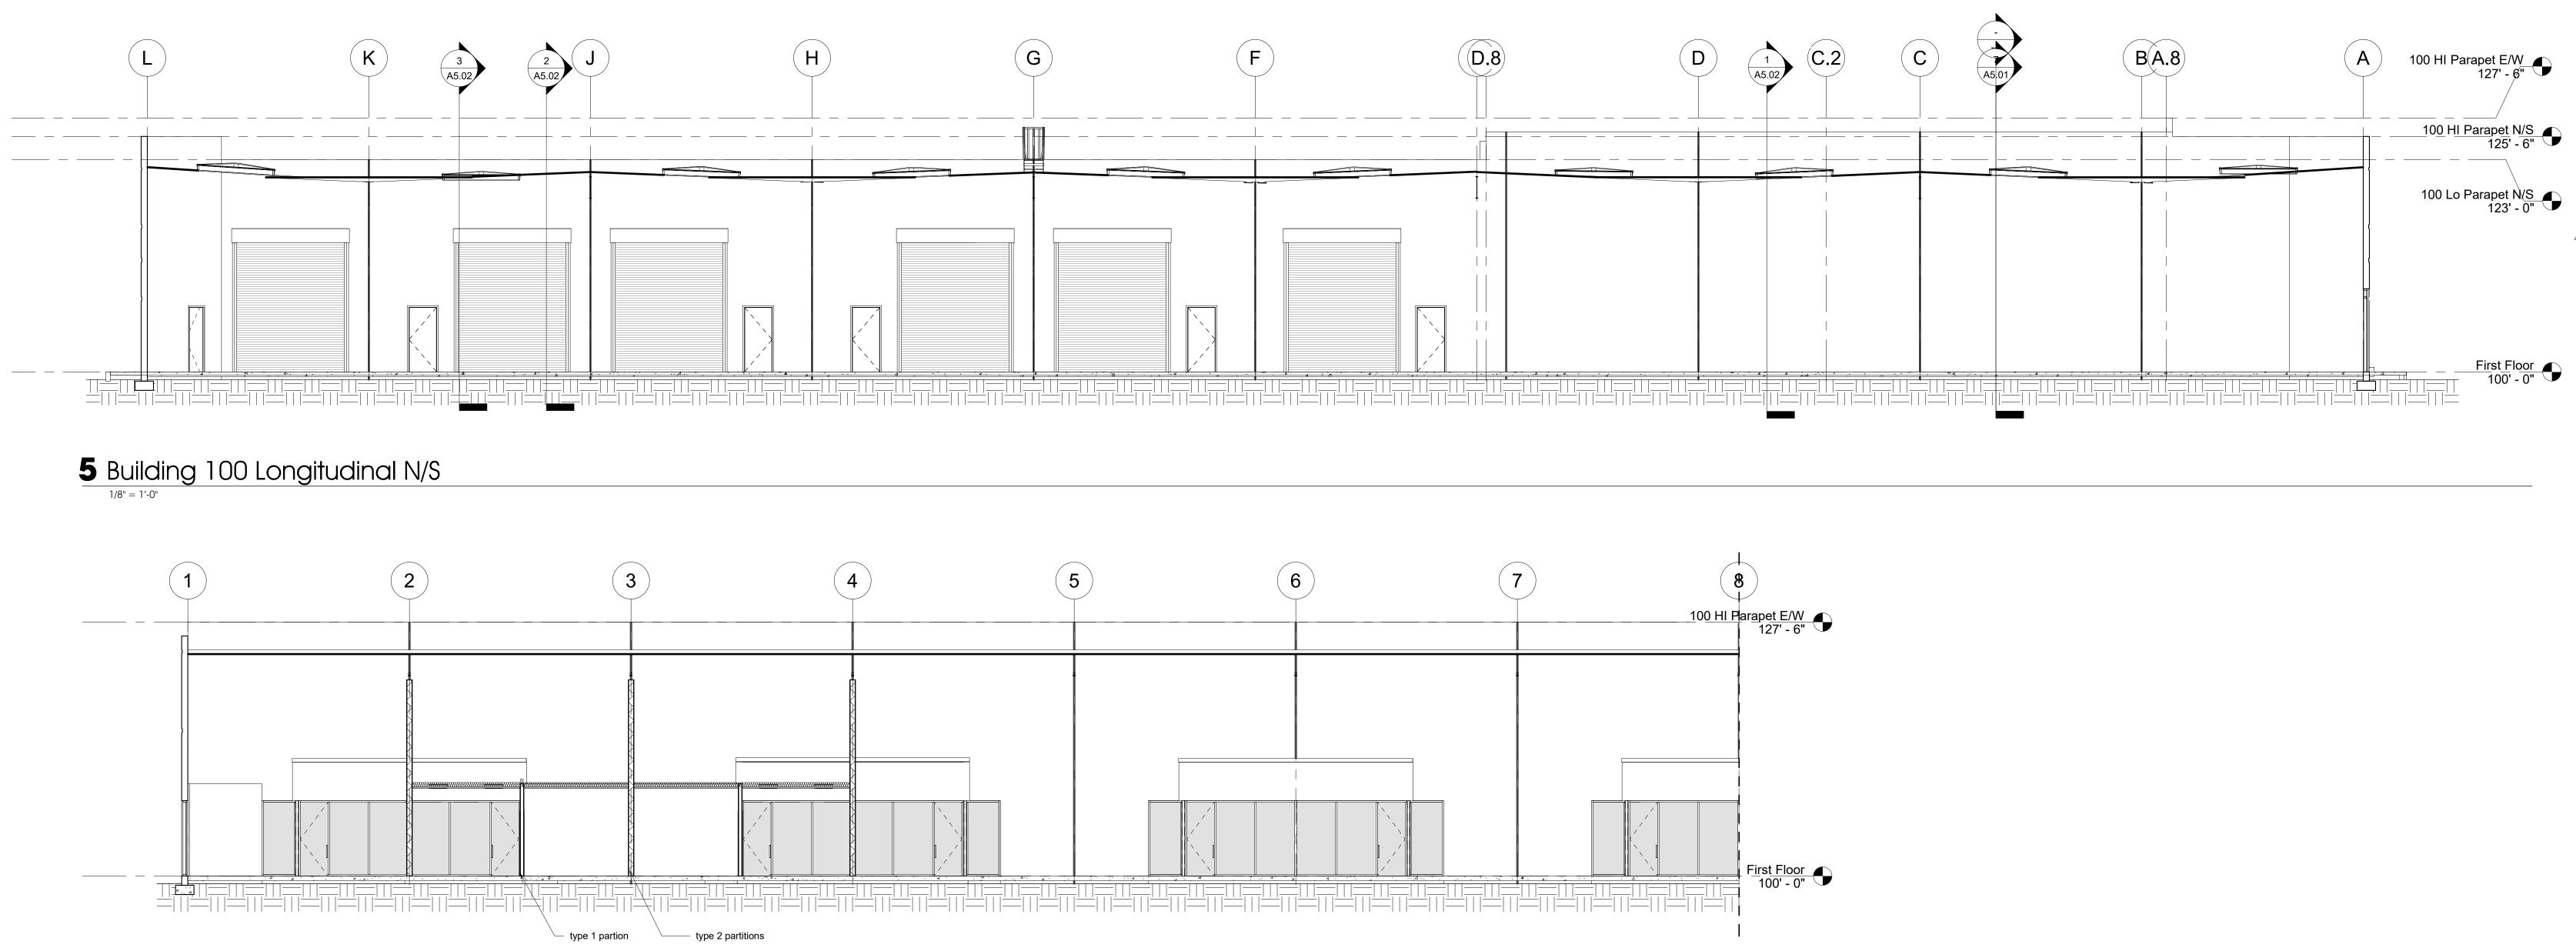
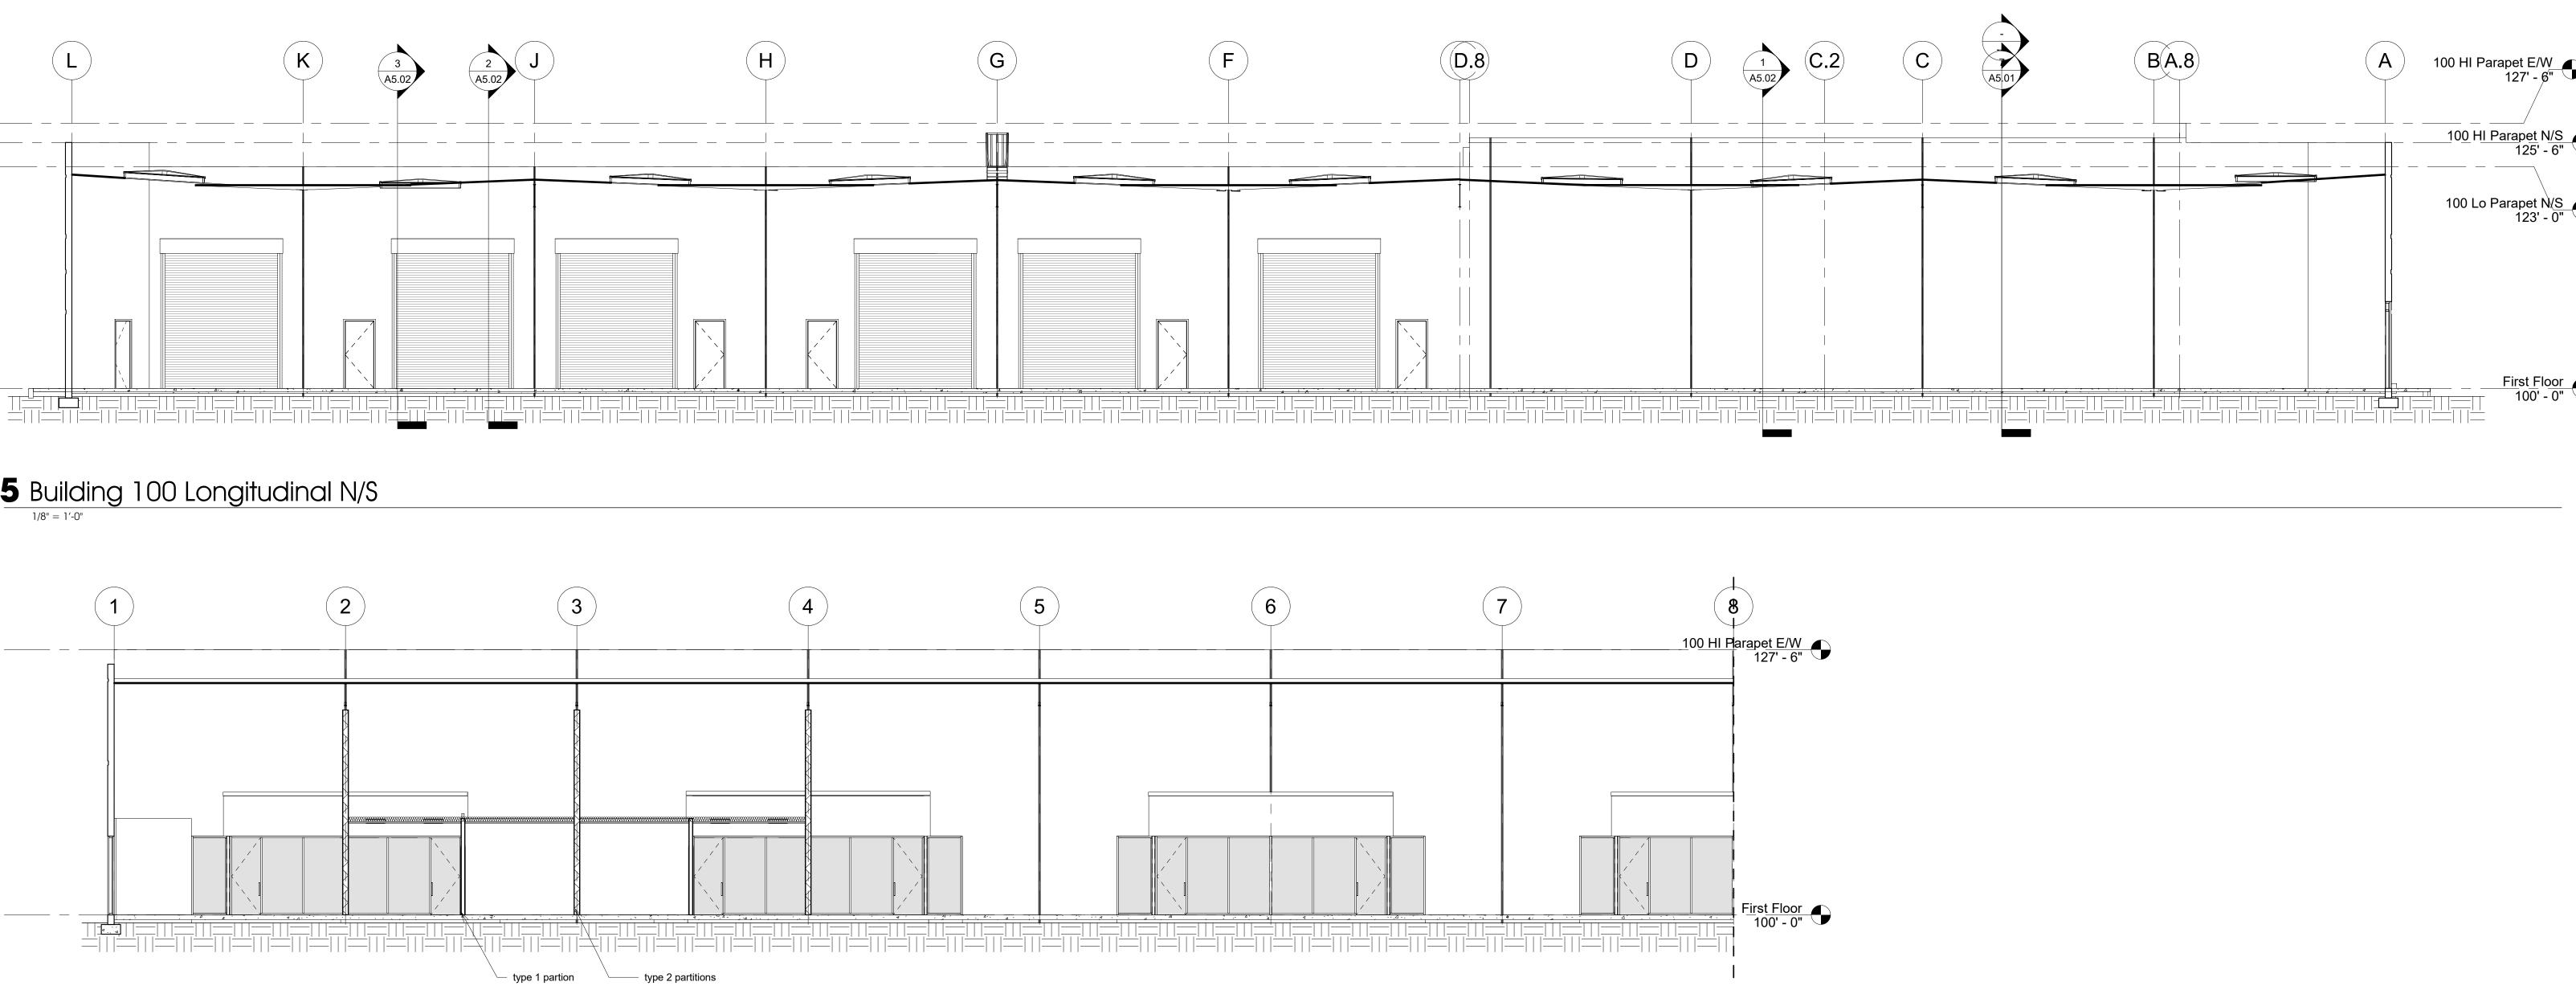
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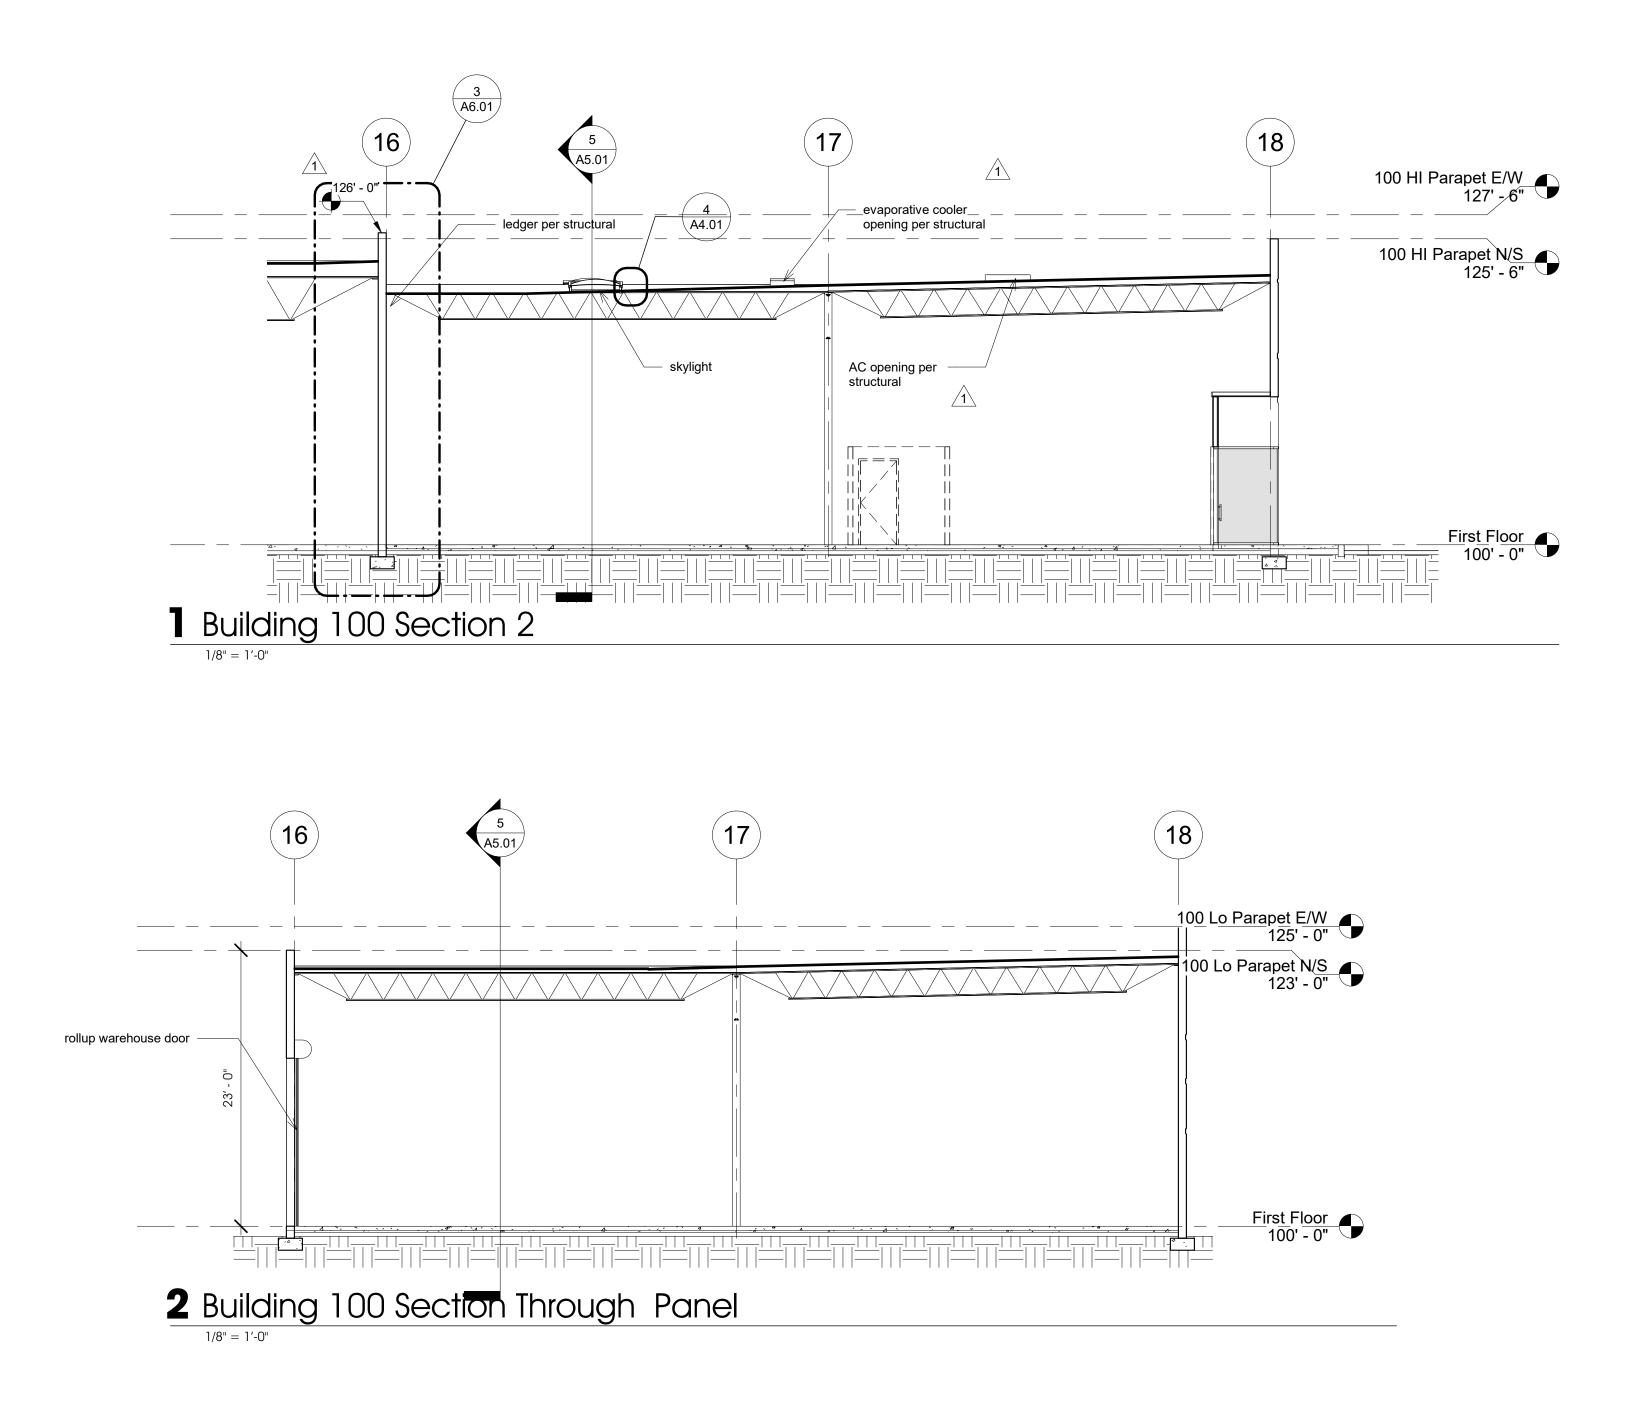
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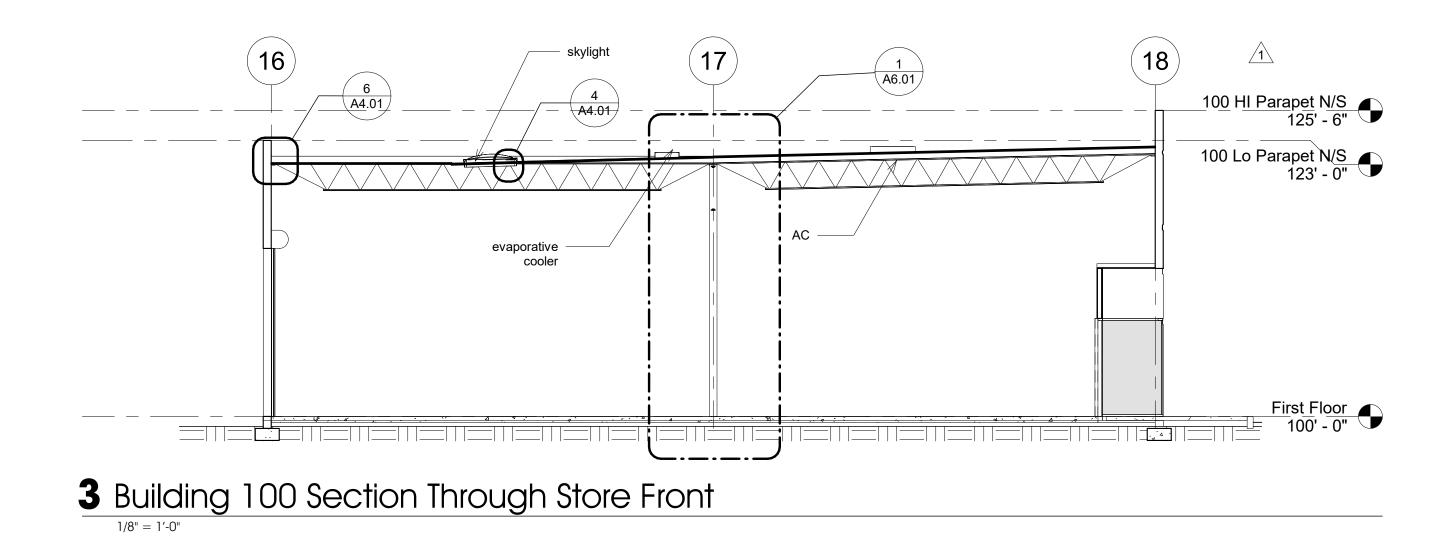
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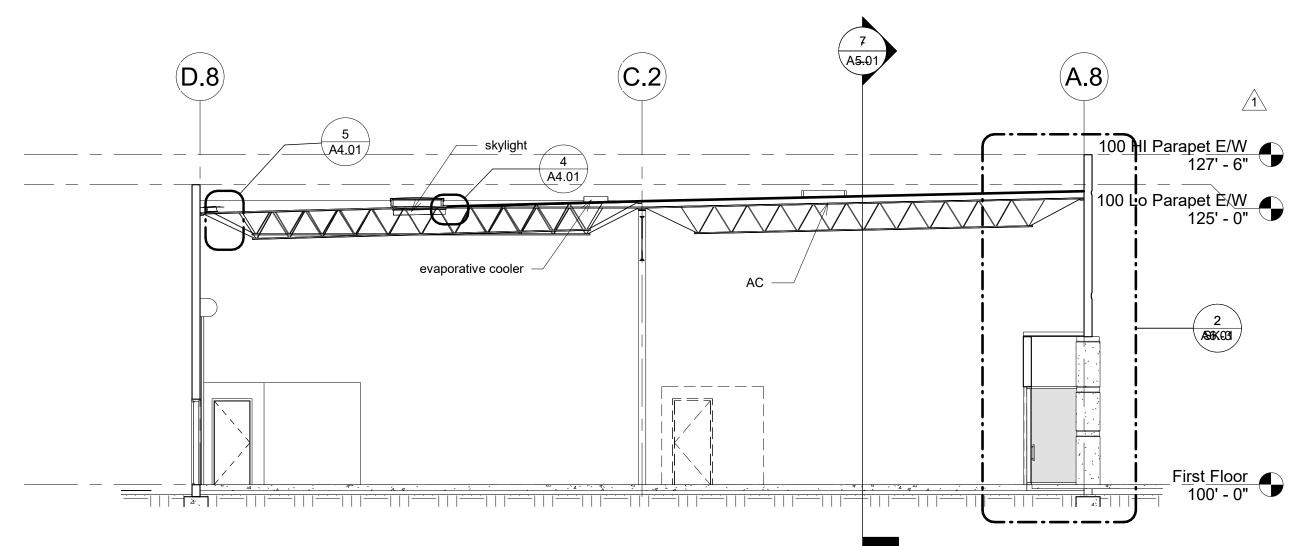
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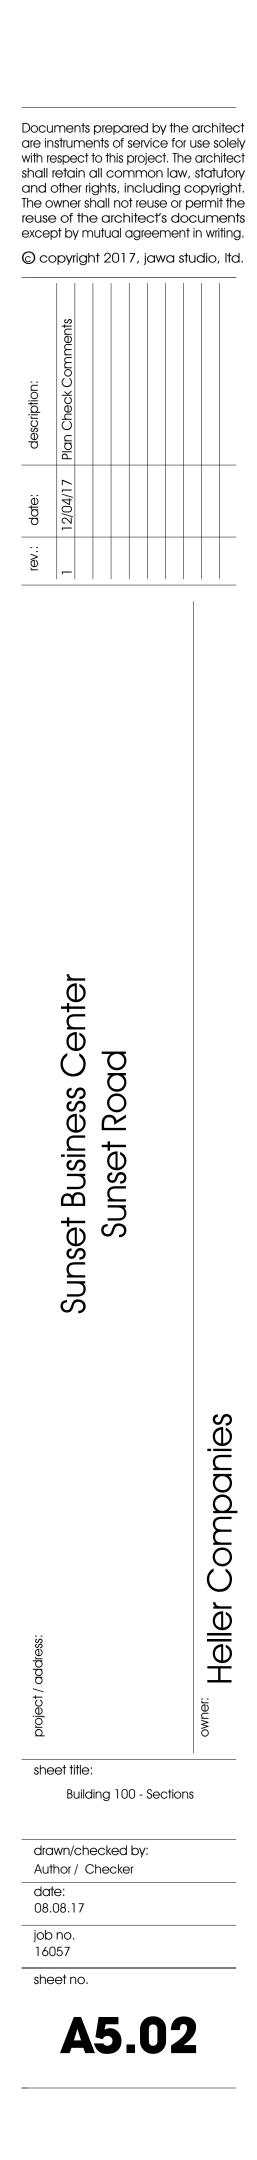



4 Building 100 Section 3


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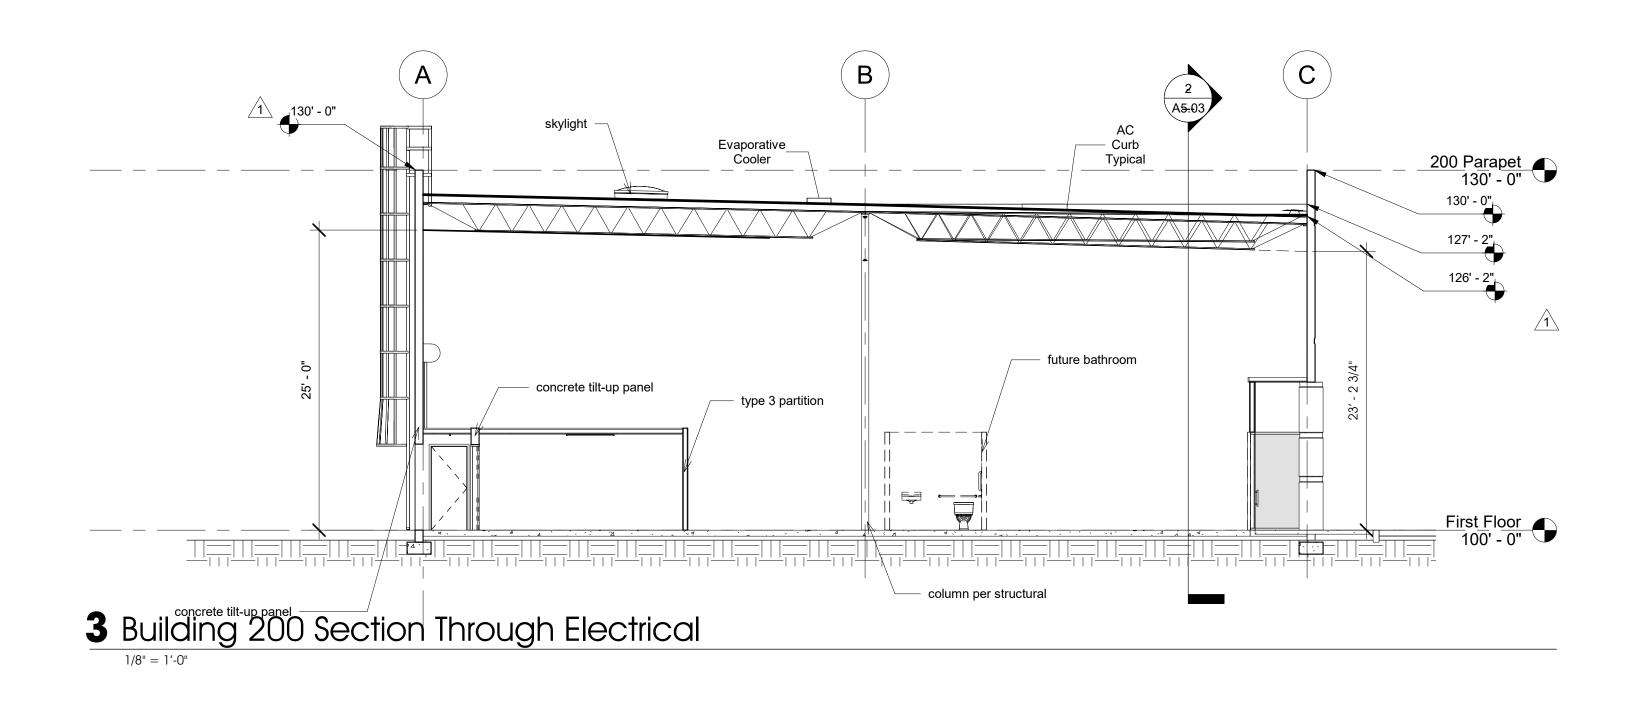



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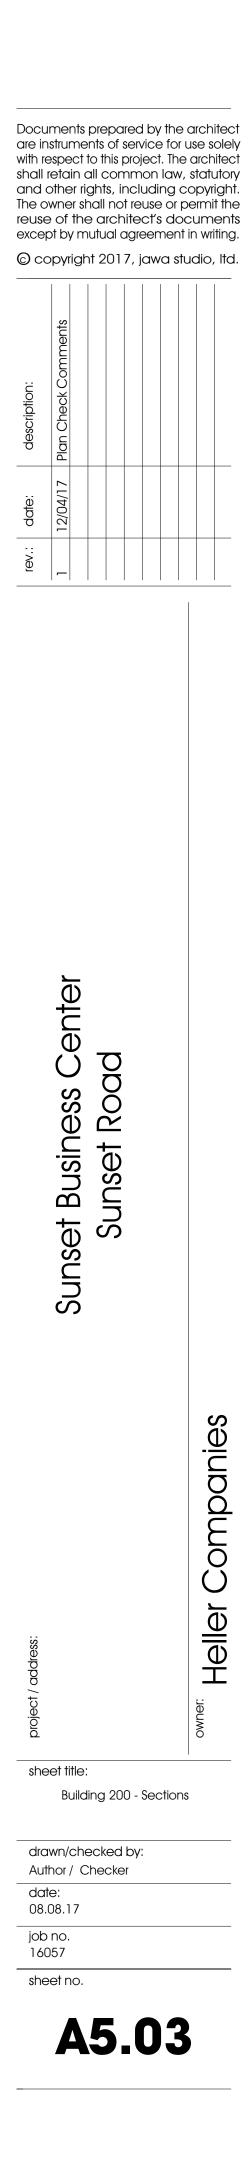




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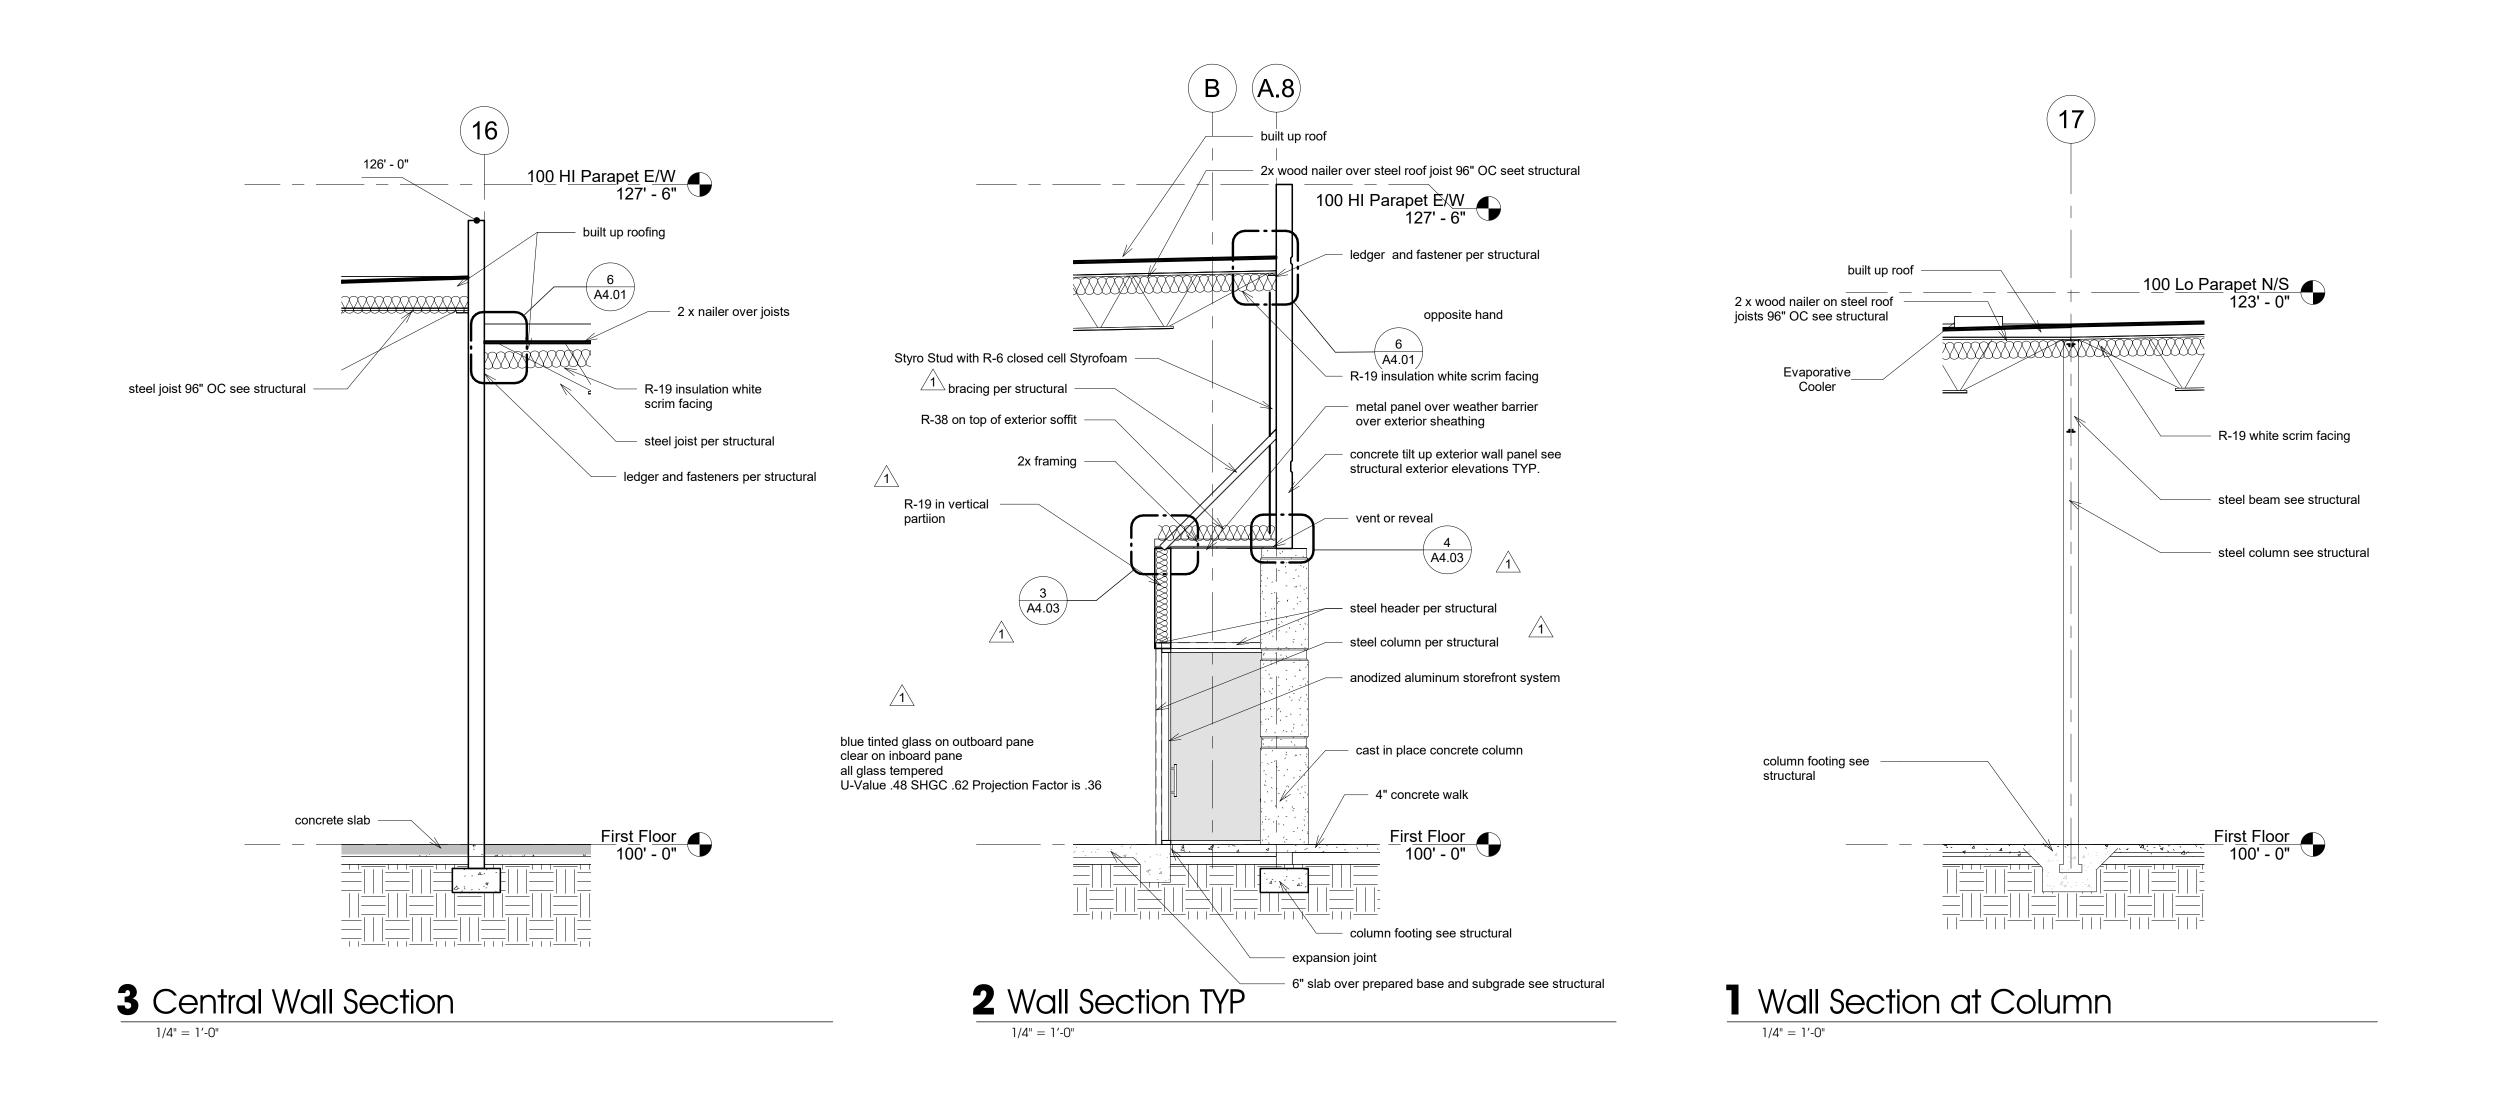

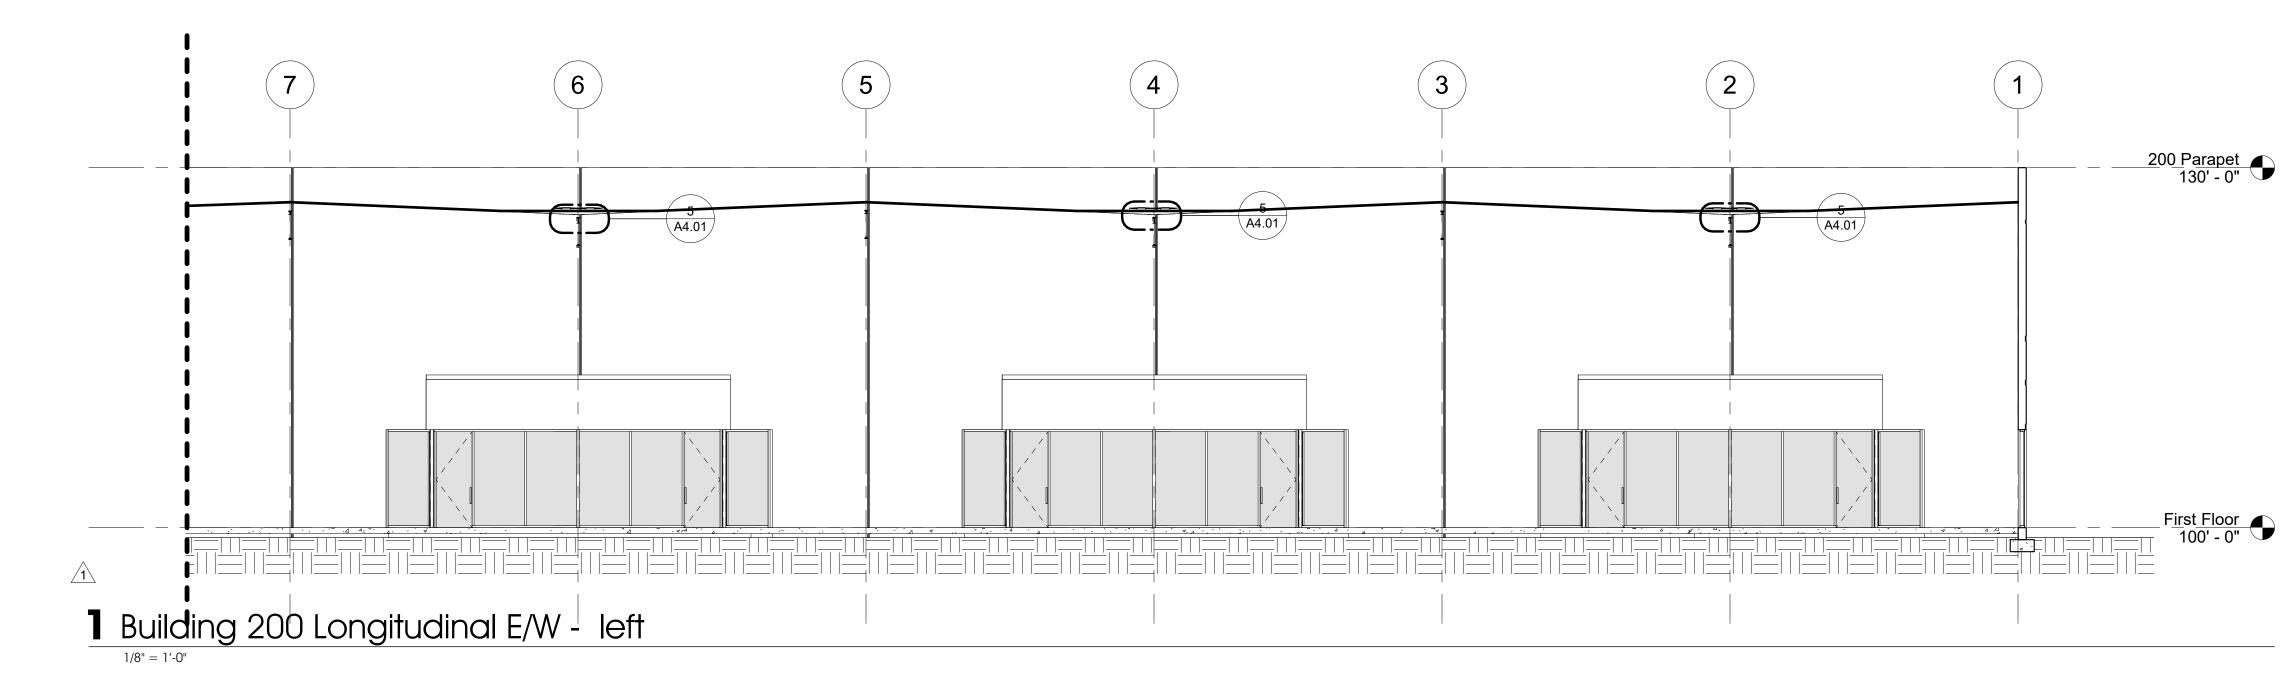
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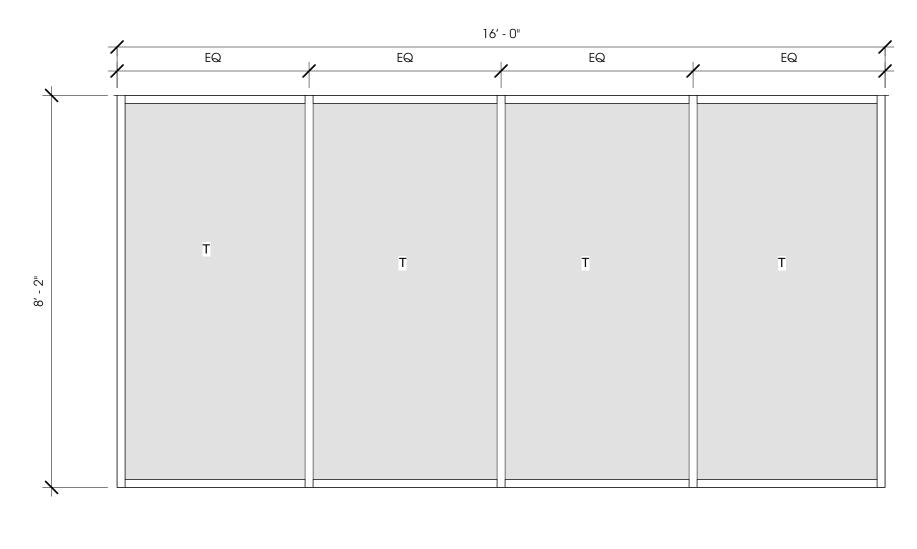
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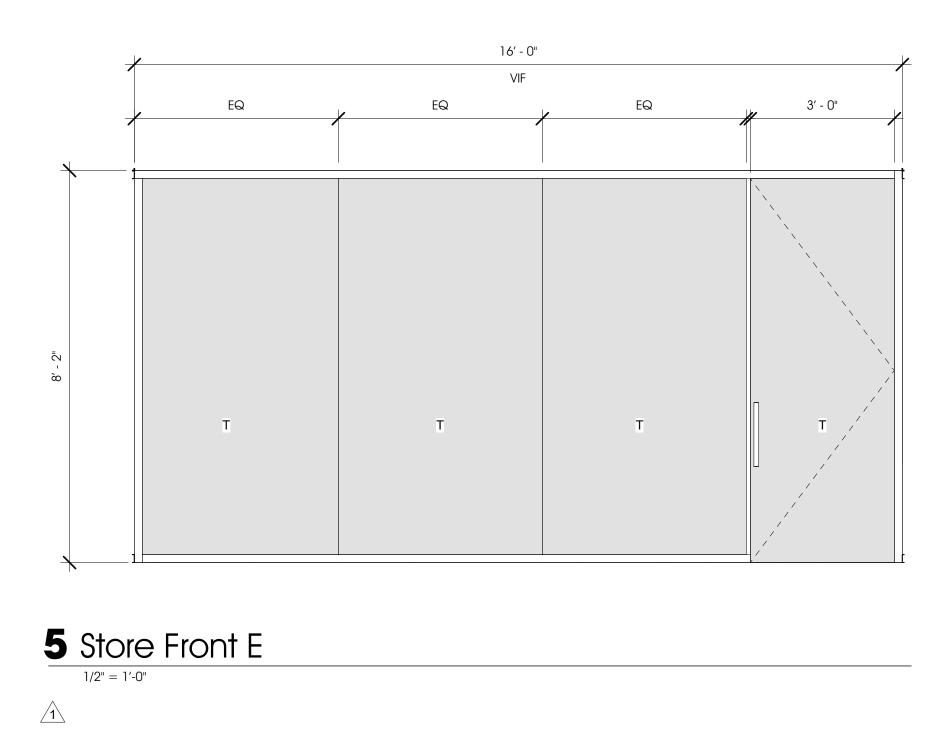


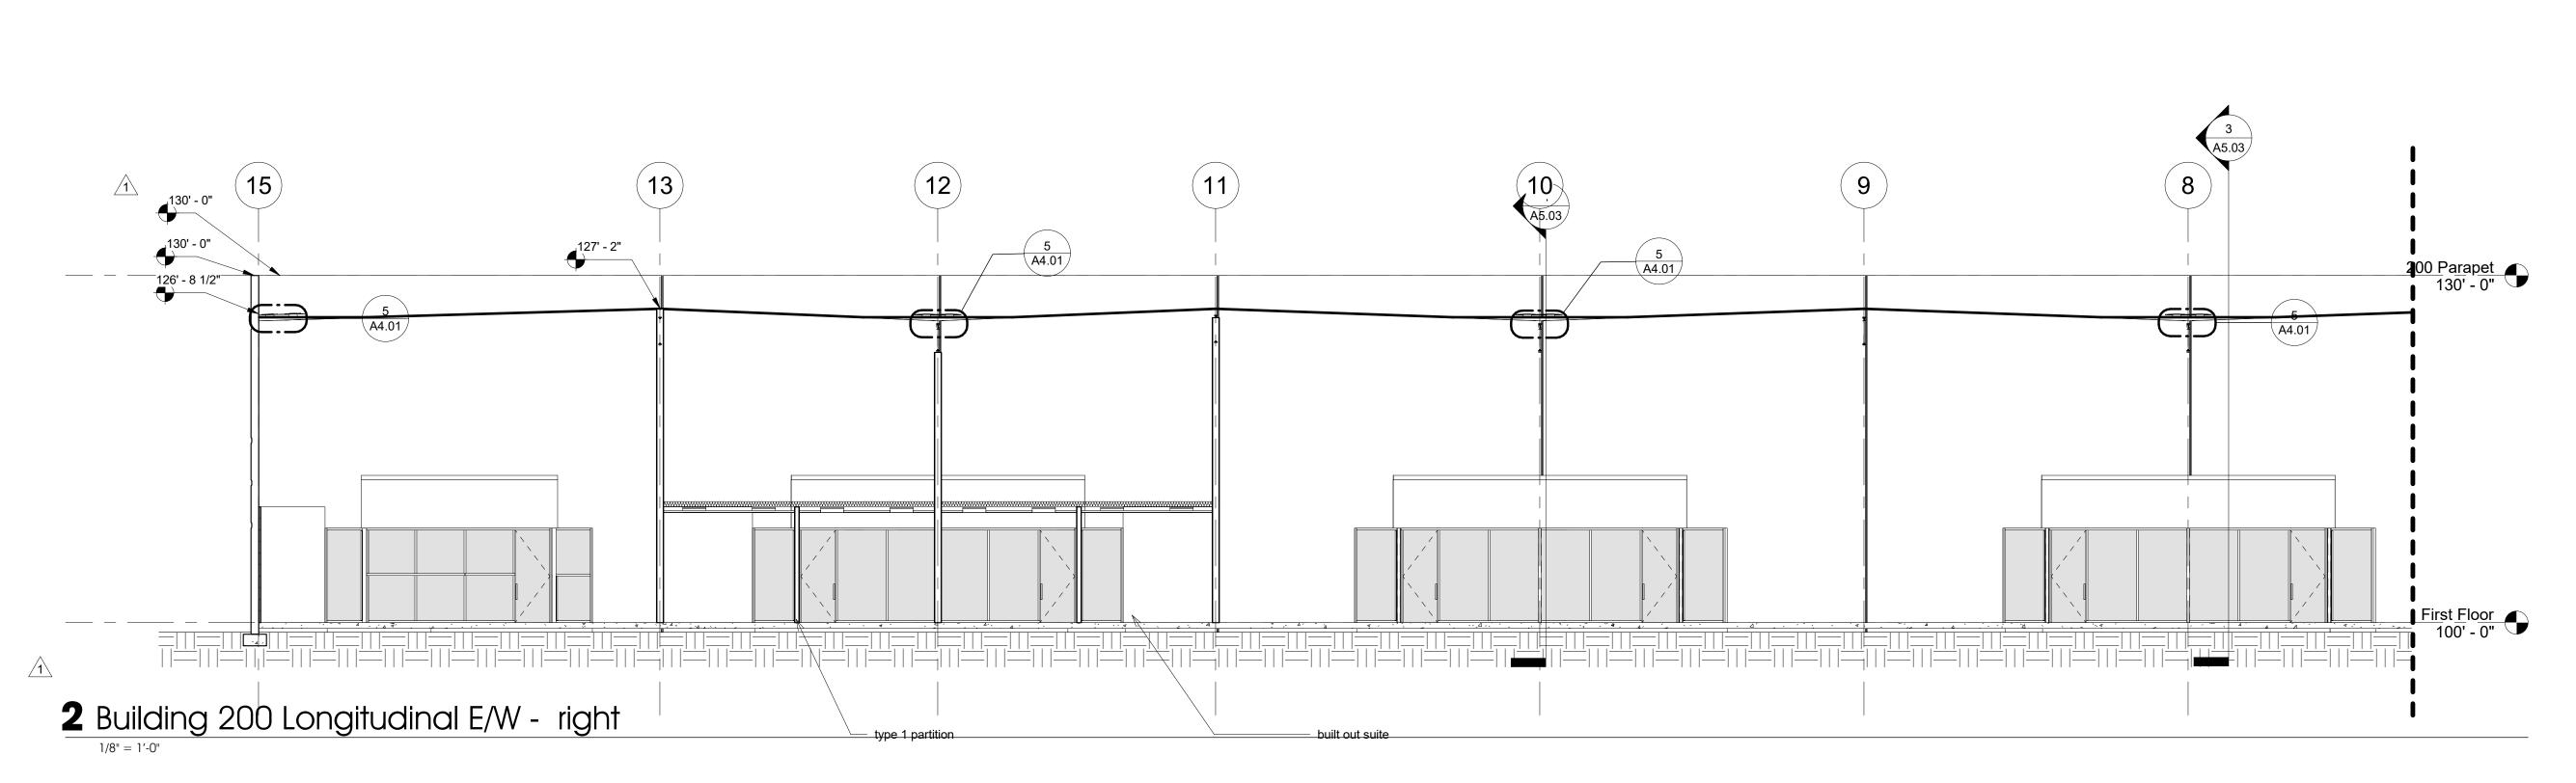
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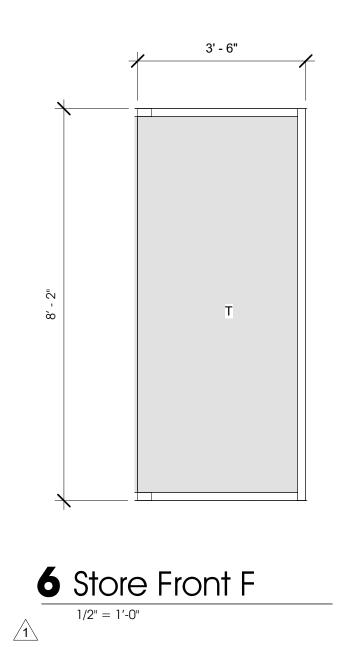


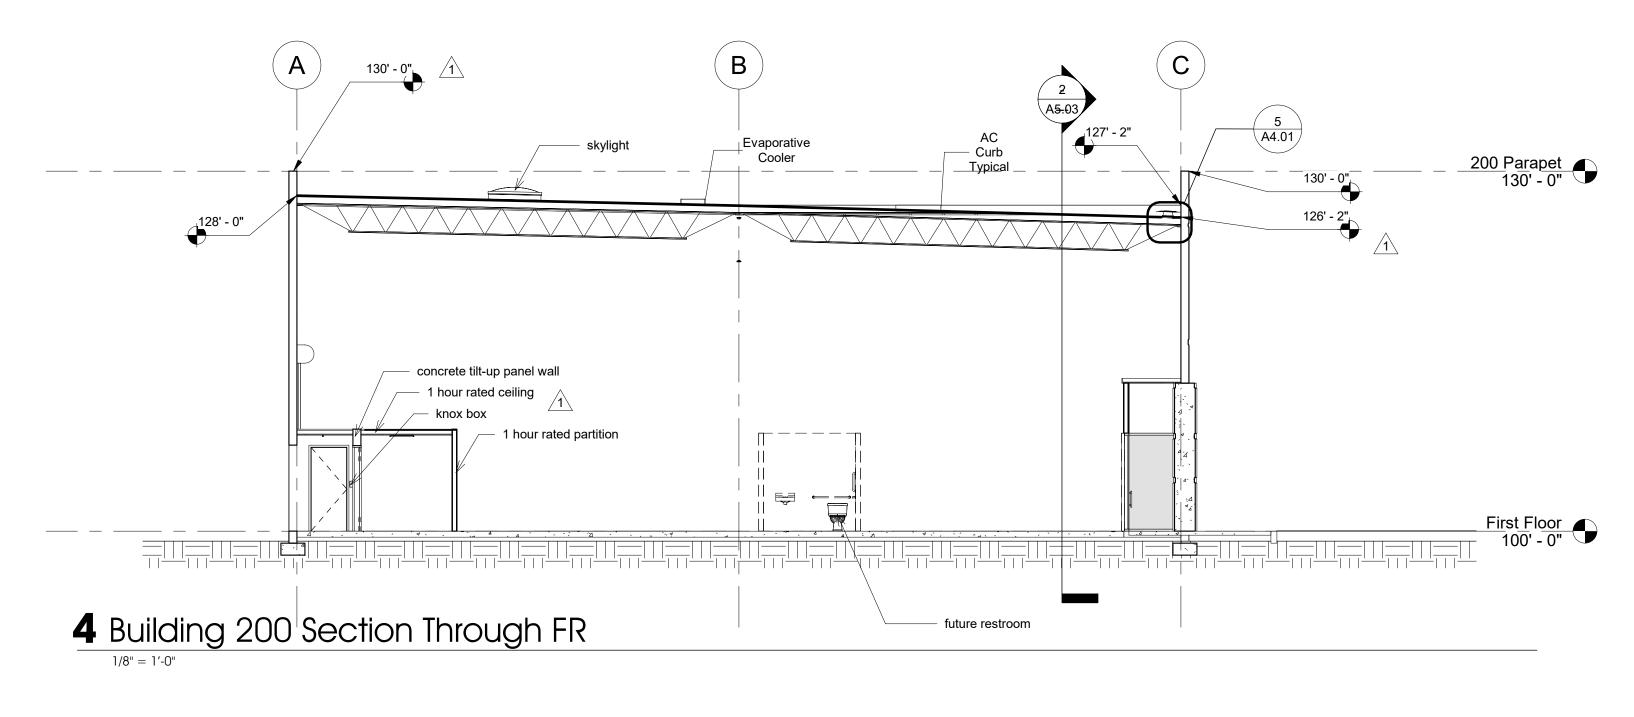









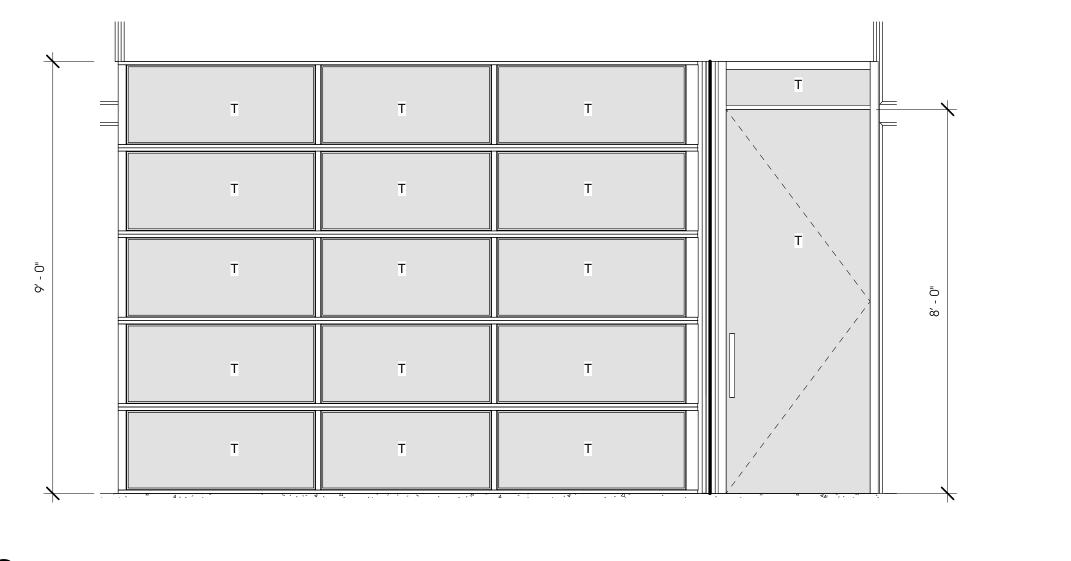

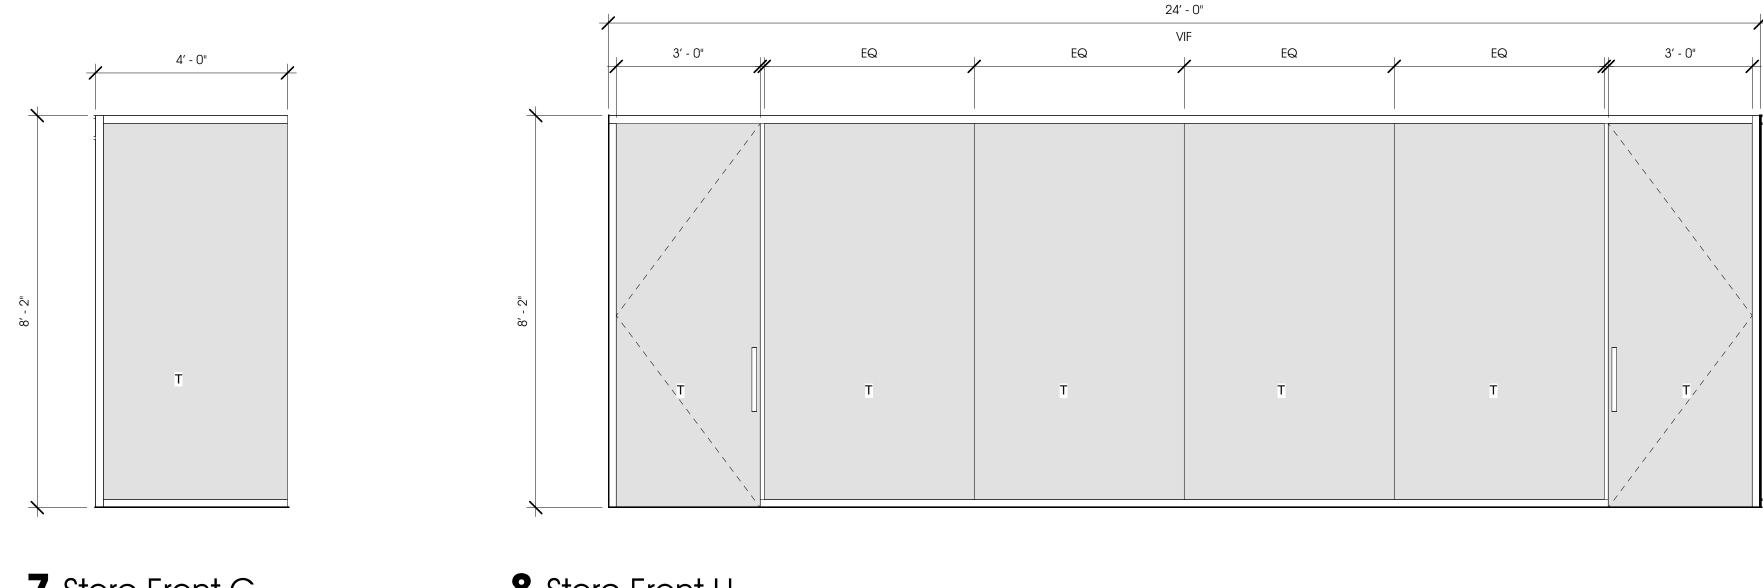



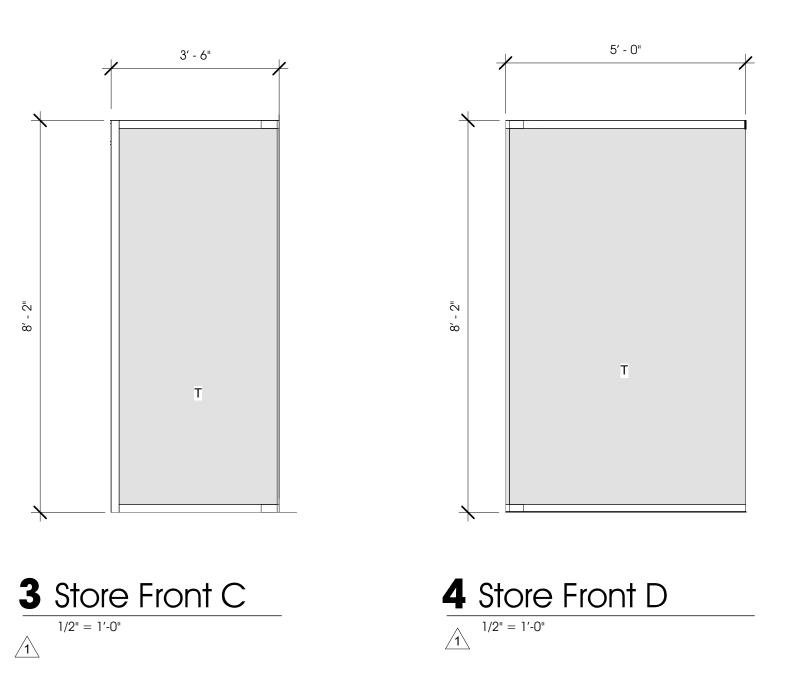

8 Store Front H

<u>/1</u> Sheet Added



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