150-11 14TH AVE QUEENS, NY 11357 PROJECT

GENERAL NOTES:

- 1. ALL DIMENSIONS ARE TO THE FINISHED FACE OF WALL UNLESS OTHERWISE NOTED.
- 2. THE GENERAL CONTRACTOR SHALL HAVE A COMPETENT SUPERINTENDENT ON THE PREMISES AT ALL TIMES WHEN THE WORK IS IN PROGRESS
- 3. GENERAL CONTRACTOR TO COORDINATE ALL WORK WITH BUILDING'S OWNER, TELEPHONE COMPANY, AND VARIOUS VENDORS DURING CONSTRUCTION AND PHASING PROCESS. 4. ALL WORK SHALL BE IN CONFORMANCE WITH THE NYC BUILDING CODES AND ALL APPLICABLE RULES AND
- REGULATIONS OF AUTHORITIES UNDER EACH JURISDICTION. 5. ALL PLUMBING AND ELECTRICAL WORK TO BE DONE BY TRADESMEN LICENSED IN THE JURISDICTION WHO WILL
- OBTAIN REQUIRED INSPECTIONS AND SIGN-OFFS. 6. THE GENERAL CONTRACTOR SHALL VERIFY ALL EXISTING CONDITIONS IN THE FIELD PRIOR TO COMMENCING WORK AND SHALL REPORT ANY DISCREPANCIES BETWEEN DRAWINGS AND FIELD CONDITIONS TO THE ARCHITECT/ENGENEER. WORK DONE AFTER THE DISCOVERY OF DISCREPANCIES AND PRIOR TO THE RECEIPT OF WRITTEN APPROVAL FOR CORRECTION BY THE ARCHITECT/ENGENEER SHALL BE AT CONTRACTOR'S RISK. NO ADDTIONAL COST WILL BE ADDED TO THE PRIOJECT DUE TO THE CONTRACTOR'S OVERSIGHT IN VERIFICATION OF EXISTING CONDITIONS.
- 7. MINOR DETAILS NOT USUALLY SHOWN OR SPECIFIED, BUT NECESSARY FOR PROPER CONSTRUCTION OF ANY PART OF THE WORK SHALL BE INCLUDED AS IF THEY WERE INCLUDED ON THE DRAWINGS.
- 8. THE CONTRACTOR SHALL BE RESPONSIBLE FOR THE PROTECTION OF ALL EXISTING CONDITIONS AND MATERIALS WITHIN THE PROPOSED CONSTRUCTION AREA. THE CONTRACTOR SHALL DESIGN AND INSTALL ADEQUATE BRACING AND SHORING FOR ALL STRUCTURALLY RELATED WORK. THE CONTRACTOR SHALL HAVE SOLE RESPONSIBILITY FOR ANY DAMAGE OR INJURIES CAUSED BY OR DURING THE EXECUTION OF THE WORK.
- 9. CHASING OR CUTTING EXISTING CORE OR EXTERIOR WALL IS NOT PERMITTED.
- 10. THE GENERAL CONTRACTOR SHALL LAY—OUT HIS OWN WORK AND SHALL PROVIDE ALL DIMENSIONS REQUIRED FOR ALL 4. KEEP AND MAINTAIN CARBON MONOXIDE DETECTING
- 11. THE GENERAL CONTRACTOR SHALL DO ALL CUTTING, PATCHING, REPAIRING AS REQUIRED TO PERFORM ALL THE WORK INDICATED ON THE DRAWINGS, AND ALL OTHER WORK THAT MAY BE REQUIRED TO COMPLETE THE JOB.
- 12. ALL WIRING SHALL BE REMOVED TO A POINT OF CONCEALMENT AND SHALL BE PROPERLY CAPPED OR PLUGGED.
- 13. THE ENGINEER/ARCHITECT OF RECORD SHALL BE NOTIFIED FOR ANY INSPECTIONS.
- 14. THE GENERAL CONTRACTOR SHALL MAINTAIN INSURANCE COVERAGE IN ACCORDANCE WITH THE BUILDING OWNER'S REQUIREMENTS.
- 15. ASBESTOS: SHOULD ANY ASBESTOS OR ASBESTOS CONTAINING MATERIAL (A.C.M.) BE UNCOVERED, IT SHOULD BUILDING DEPARTMENT NOTES: BE REPORTED IMMEDIATELY TO THE OWNER AND ARCHITECT/ENGENEER. THESE CONTRACT DOCUMENTS DO
- NOT INCLUDE THE REMOVAL OF ANY ASBESTOS OR A.C.M. 16. BEFORE COMMENCING WORK, CONTRACTOR SHALL FILE ALL NECESSARY CERTIFICATES OF INSURANCE AND FAMILIARIZE HIMSELF WITH THE BUILDING RULES AND REGULATIONS.
- 17. CONTRACTOR SHALL TAKE ALL NECESSARY PRECAUTIONS TO PROTECT THESE UTILITIES FROM DAMAGES OR DESTRUCTION. CONTRACTOR ALSO RESPONSIBLE TO PROTECT ALL ADJOINING PROPERTIES BOTH PUBLIC AND PRIVATE AND TAKE ALL SAFETY PRECAUTIONS TO PROTECT THE HEALTH, SAFETY AND WELFARE OF THE IMMEDIATE AREA.
- 18. THE ENGINEER OF DESIGN SHALL NOT BE RETAINED AS SITE INSPECTOR OR SUPERVISOR DURING CONTRUCTION.
- 19. THE OWNER SHALL RETAIN A NYS/NYC REGISTERED SPECIAL INSPECTION AGENCY FOR ALL REQUIRED INSPECTIONS DURING CONSTRUCTION.

SMOKE DETECTOR NOTES

- 1. SMOKE DETECTORS SHALL BE INSTALLED AS REQUIRED BY SUBCHAPTER 17 ARTICLE 6 ENTITLED, "SMOKE DETECTING DEVICES" (C26-1705.0) IN DWELLING
- DETECTORS SHALL BE EITHER IONIZATION CHAMBER OR PHOTELECTRIC TYPE AND TO COMPLY WITH RS17-11.
- 3. UNITS TO BE APPROVED BY BOARD OF STANDARDS AND APPEALS, ACCEPTED PURSUANT TO RULES AND REGULATIONS PROMULGATED BY THE COMMISSIONER OF LISTED BY AN ACCEPTABLE TESTING LABORATORY, SUCH AS UNDERWRITER'S LABORATORY
- 4. UNITS SHALL BE INSTALLED IN AREAS DESIGNATED ON PLANS; THEY SHALL BE LOCATED ON OR NEAR THE CEILING AND WITHIN 15'-0" OF ANY ROOMS USED FOR SLEEPING PURPOSES, FOR DWELLING UNITS WITH MULTIPLE LEVELS, WHEN ANY LEVEL HAS ONLY ON MEANS OF EGRESS UNITS SHALL BE PROVIDED AT ALL
- LEVELS. SMOKE DETECTORS SHALL BE INSTALLED AS FOLLOWS: (A) CEILING MOUNT — CLOSEST EDGE OF UNIT SHALL BE MINIMUM OF 4" FROM ANY WALL. (B) WALL MOUNT - CLOSEST EDGE OF UNIT SHALL BE MINIMUM OF 6" AND A MAXIMUM OF 12" FROM CEILING.

CARBON MONOXIDE DETECTOR NOTES:

- HARD WIRED CARBON MONOXIDE DETECTORS WITH BATTERY BACK-UP WILL BE PROVIDED IN EACH APARTMENT WITHIN FIFTEEN OF EVER BEDROOM.
- 2. SUCH CARBON MONOXIDE DETECTING DEVICE MAY BE COMBINED WITH A SMOKE DETECTING DEVICE THAT COMPLIES WITH THE PROVISIONS OF THIS TITLE AND ANY APPLICABLES RULES PROMULGATED THERE UNDER
- 3. ALL CARBON MONOXIDE DETECTING DEVICES REQUIRED TO BE PROVIDED AND INSTALLED PURSANT TO THIS ARTICLE SHALL BE OF A TYPE AUTHORIZED BY THE RULES
- PROMULGATED BY THE COMMISSIONER 27-9812(a)
- DEVICES IN GOOD REPAIR 5. REPLACE ANY CARBON MONOXIDE DETECTING DEVICES WHICH HAS BEEN STOLEN, REMOVED, FOUND, MISSING OR RENDERED INOPERABLE PRIOR TO THE OCCUPANCY OF A DWELLING UNIT.
- 6. KEEP SUCH RECORDS AS THE COMMISIONER SHALL PRESCRIBE RELATING TO THE INSTALLATION AND MAINTENANCE OF CARBON MONOXIDE DETECTING DEVICES IN THE BUILDING AND MAKE SUCH RECORDS AVAILABLE TO THE COMMISSIONER UPON REQUEST

- 1. ALL DOORS TO BE INCOMBUSTIBLE.
- 2. DUCTS, PIPES AND CONDUITS PASSING THROUGH RATED CONSTRUCTION SHALL COMPLY WITH SECTION 27-343 OF THE BUILDING CODE.
- 3. ALL WOOD TO BE FIRE-PROOF AS PER SECTION 27-328, RS 5-3 AND 5-5 OF THE BUILDING CODE L.L. 76
- 4. ALL MATERIALS, ASSEMBLIES, FORMS AND METHODS OF CONSTRUCTION AND SERVICE EQUIPMENT SHALL COMPLY WITH THE REQUIREMENT OF SECTION 27-131 OF THE BUILDING CODE.
- 5. NO MATERIAL OF ANY MANUFACTURE OR PRODUCER SHALL BE ACCEPTABLE FOR USE INTENDED UNLESS AND UNTIL THE MATERIAL HAS BEEN TESTED FOR COMPLIANCE WITH LOCAL CODE REQUIREMENTS.

HORIZONTAL EXTENSION OF EXISTING COMMERCIAL SPACE ON 1ST FLOOR. NO CHANGE IN USE, EGRESS OR OCCUPANCY.

INDEX OF DRAWING

DWG #	TITLE
G-001.00	GENERAL NOTES
EN-001.00	ENERGY CODE ANALYSIS, DOOR SCHEDULE
DM-001.00	PARTIAL DEMO. PLANS
DM-002.00	PARTIAL DEMO ELEVATIONS
A-001.00	PROPOSED PLANS
A-002.00	PROPOSED ELEVATIONS
A-003.00	ROOF PLAN
A-004.00	SECTION AND FRAMING PLAN
A-005.00	ROOF PLAN
SOE-001.00	EXAVATION PLAN AND FOUNDATION
A-006.00	DETAILS

LIST OF SPECIAL INSPECTIONS

SPECIAL INSPECTIONS	CODE / SECTION
CONCRETE - CAST-IN-PLACE	BC 1704.4
MASONRY	BC 1705.4
FIRE-RESISTANT PENETRATIONS AND JOINTS	BC 1704.27

PROGRESS INSPECTIONS		CODE / SECTION
FIRE-RESISTANCE RATED CONSTRUCTION		BC 110.3.4
FINAL	28-116.2.4.2, BC	110.5, and 1 RCNY §101-10
STRUCTRUAL WOOD FRAME		BC 110.3.3
FOOTING AND FOUNDATION		BC 110.3.1
ENERGY CODE COMPLIANCE INSPECTIONS		BC 110.3.5

INSULATION REPLACEMENT AND R-VALUES	(IA2),(IIA2)
FENESTRATION AND DOOR U-FACTOR, PRODUCT RATINGS	(IA3),(IIA3)
FENESTRATION RATINGS FOR AIR LEAKAGE	(IA4),(IIA4)
FENESTRATION AREAS	(1A5),(IIA5)
AIR BARRIER — VISUAL INSPECTION	(1A6),(IIA6)

-150-11 14th Ave, Queens NY 11357



Tax Block: 4518 Tax Lot: 56 BIN: 4573539 Zoning:R3-2 & C1-2 overlay Zoning Map: 7D

U.O.N

WAM

FL

EX.

AFF	ABOVE FINISH FLOOR
BLDG	BUILDING
CONC	CONCRETE
DRY	DRYFR
D/W	DISH WASHER
FD FD	FLOOR DRAIN
GWB	GYPSUM BOARD
	HEIGHT
HT	
HWH	HOT WATER HEATER
MAX.	MAXIMUM
MIN.	MINIMUM
NTS	NOT TO SCALE
OC	ON CENTER
REF	REFRIGERATOR
RM	ROOM
SD	SMOKE DETECTOR
TYP.	TYPYCAL

UNLESS OTHERWISE NOTED

WASHING MACHINE

FLOOR


EXISTING

DRAWING SYMBOLS



PARTITION TYPE

WINDOW NUMBER DOOR NUMBER

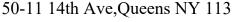

150-11 14th Ave,Queens NY 11357

PROJECT LOCATION:

PROJECT NAME:


INTERIOR RENOVATION

HUAN DESIGN INC

TEL: 646.797.6980

136-20 38TH AVE #11A, FLUSHING, NY, 11354

EMAIL:huanarchitect@gmail.com

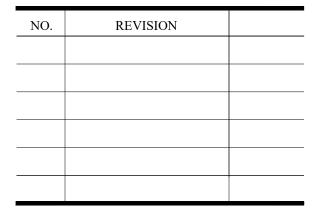

B-SCAN:

NYC DOB STAMPS AND SIGNATURES:



DRAWING TITLE:

GENERAL NOTES

Q00886404-I1



DATE: 11-22-2022 PROJECT NO.: 22.022 DRAWN BY:ZX CHECK BY: ZX SHEET NO.: G-001.00 PAGE: 1 of 11

E.C.C. OF NYC COMPLIANCE STATEMENT: TO THE BEST OF MY KNOWLEDGE, BELIEF AND PROFESSIONAL JUDGEMENT, ALL WORK UNDER THIS APPLICATION IS IN COMPLIANCE WITH 2020 ENERGY CONSERVATION CODE OF NEW YORK CITY, USE CHAPTER C4 FOR RESIDENTIAL BUILDING.

CLIMATE ZONE TABLE:

COUNTY	CLIMATE ZONE
QUEENS	4A

TABLE I — PROGRESS INSPECTIONS FOR 2020 ENERGY CODE COMPLIANCE — RESIDNTIAL BUILDINGS

	INSPECTION/TEST	PERIODIC (MINIMUM)	REFERENCE STANDARD (SEE ECC CHAPTER 6) OR OTHER CRITERIA	ECC OR OTHER CITATION
IA	ENVELOPE INSPECTIONS			
IA2	INSULATION PLACEMENT AND R-VALUES: INSTALLED INSULATION FOR EACH COMPONENT OF THE CONDITIONED SPACE ENVELOPE AND AT JUNCTIONS BETWEEN COMPONENTS SHALL BE VISUALLY INSPECTED TO ENSURE THAT THE R-VALUES ARE MARKED, THAT SUCH R-VALUES CONFORM TO THE R-VALUES IDENTIFIED IN THE CONSTRUCTION DOCUMENTS AND THAT THE INSULATION IS PROPERLY INSTALLED. CERTIFICATIONS FOR UNMARKED INSULATION SHALL BE SIMILARLY VISUALLY INSPECTED.	AS REQUIRED TO VERIFY CONTINUOUS ENCLOSURE WHILE WALLS, CEILINGS AND FLOORS ARE OPEN	APPROVED CONSTRUCTION DOCUMENTS	C303.1, C303.1.1 C303.1.2, C402.1 C402.2, Table C402.4.1.1, C402.4.4, C402.6
IA3	FENESTRATION U-FACTOR AND PRODUCT RATINGS: U-FACTORS OF INSTALLED FENESTRATION SHALL BE VERIFIED BY VISUAL INSPECTION FOR CONFORMANCE WITH THE U-FACTORS IDENTIFIED IN THE CONSTRUCTION DRAWINGS, EITHER BY VERIFYING THE MANUFACTURER'S NFRC LABELS OR, OR, WHERE NOT LABELED, USING THE RATINGS IN ECC TABLES 303.1.3(1), (2) AND (2).	AS REQUIRED DURING INSTALLATION	APPROVED CONSTRUCTION DRAWINGS; NFRC 100	C303.1, C303.1.3, C402.1, C402.3, C402.5
IA4	FENESTRATION AIR LEAKAGE: WINDOWS SKYLIGHT AND SLIDING GLASS DOORS, EXCEPT SITE—BUILT WINDOWS SKYLIGHTS AND DOORS, SHALL BE VISUALLY INSPECTED TO VERIFY THAT INSTALLED ASSEMBLIES ARE LISTED AND LABELED TO THE REFERENCED STANDARD.	AS REQUIRED DURING INSTALLATION	NFRC 400, AAMA/WDMA/CSA 101/I.S.2/A440	C402.4.3
IA5	FENESTRATION AREAS: DIMENSIONS OF WINDOWS, DOORS AND SKYLIGHTS SHALL BE VERIFIED BY VISUAL INSPECTION.	PRIOR TO FINAL CONSTRUCTION INSPECTION	APPROVED CONSTRUCTION DOCUMENTS	C402.3
IA6	AIR SEALING AND INSULATION — VISUAL INSPECTION: OPENINGS AND PENETRATIONS IN THE BUILDING ENVELOPE, INCLUDING SITE—BUILT FENESTRATION AND DOORS, SHALL BE VISUALLY INSPECTED TO VERIFY THAT THEY ARE PROPERLY SEALED, IN ACCORDANCE WITH TABLE 402.4.1.1.	AS REQUIRED DURING ENVELOPE CONSTRUCTION	APPROVED CONSTRUCTION DOCUMENTS; ASTM E283;	C402.4.1, C402.4.4, C402.4.5 C4.2.4.6

<u>Energy tabular analysis for alteration—climate zone 4a</u>

ELEMENT(ITEM DESCRIPTION)	PROPOSED DESIGN VALUE	CODE PRESCRIPTIVE VALUE	SUPPORTING DOCUMENTATION
NEW ADDITION ROOF	R-33 CI	R-33 CI(TABLE R402.1.3)	EN-001.00 & A-004.00
NEW MASS WALL	R-11.2 CI	R-11.2 CI (TABLE R402.1.3)	EN-001.00 & A-004.00
NEW WOOD DOOR(SOLID)	EXEMPT	ONE SIDE-HINGED OPAQUE DOOR ASSEMBLY UP TO 24 SQUARE FEET IN AREA IS EXEMPTED FROM THE U-FACTOR REQUIREMENT (TABLE R402.1.4)	EN-001.00 & A-004.00

NEW DOOR SCHEDULE						U-FACTOR				
NO	NO. DOOR NAME SIZE FIRE CODE CONST. FRAME FINISH REMARKS									
	SINGLE HINGED	3'-0"	6'-8"	1 3/8"	NFPA 80	WOOD	WOOD	PAINT	ENTRY DOOR	_



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PROJECT NAME:

INTERIOR RENOVATION

NO.	REVISION	

NYC DOB STAMPS AND SIGNATURES:




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ENERGY CODE ANALYSIS, DOOR SCHEDULE

Q00886404-I1


SEAL & SIGNATURE: DATE: 11-22-2022 PROJECT NO.:22.022 DRAWN BY:ZX CHECK BY: ZX

	ZONING CALCULATION:	
	1 ZONING LOT, 1 TAX LOT ZONING DISTRICT: R3-2;C1-2 BLOCK: 4518 LOT: 56 USER GROUP: 6 ZONING MAP: 7d DEPTH OF COMMERCIAL OVERLAY: 150'	
	BULK REGULATION(COMPLIANCE WITH ZR ARTICAL III, CHAPTER 3):	
	EXISTING LOT AREA=6874 SF	
ZR 12-10 ZR 33-121	FLOOR AREA (SEE AREA CACULATION) PROPOSED CELLAR FLOOR AREA: PROPOSED FIRST FLOOR AREA: PROPOSED SECOND FLOOR AREA: TOTAL ZONING FLOOR AREA = 4983 SF. TOTAL GROSS FLOOR AREA = 5503 SF. TOTAL MAXFAR = 1	FLOOR AREA)
	FAR= 4983/ 6874 = 72.49% = 73%	OK
ZR 33-20	N/A GOVERNED BY YARD REQUIRMENTS	
ZR 23-20 ZR 23-22	MAXIMUM NUMBER OF DWELLING UNITS OR ROOMING UNITS FACTOR FOR D.U. IN R4A =1280 2324 / 1280 = 1.82 =1 UNIT EXIST = PROPOSED = 1 UNIT	OK.
ZR 35-50	FRONT YEARD NOT REQUIRED	OK.
ZR 33-291	REQUIRED MIN. REAR YARD = 8' PROPOSED REAR YARD = 25'	OK.
ZR 33-291	SIDE YARD REQUIRED 8' PROPOSED =8'-6"	OK
ZR 33-431	STREET WALL HEIGHT = 30', INITIAL SET BACK IN NARROW STREET=20' SLOPE EXIST.=PROPOSED = 25' < 30'	ANGLE: 1:1=45 DEGREE
ZR 36-21 ZR 36-23	USE IN PRC-B USE GROUP 6 1 PER 300SF FOR C1-2 TOTAL REQUIRED PARKING = 4111SF/300SF = 13.7 = 14 PARKING 15 PARKING WAIVER FOR C1-2 0 PARKING IS REQUIRED 1 OSP PARKING IS PROVIDED FOR EXISTING 2ND FLOOR 1 FAMILY	OK

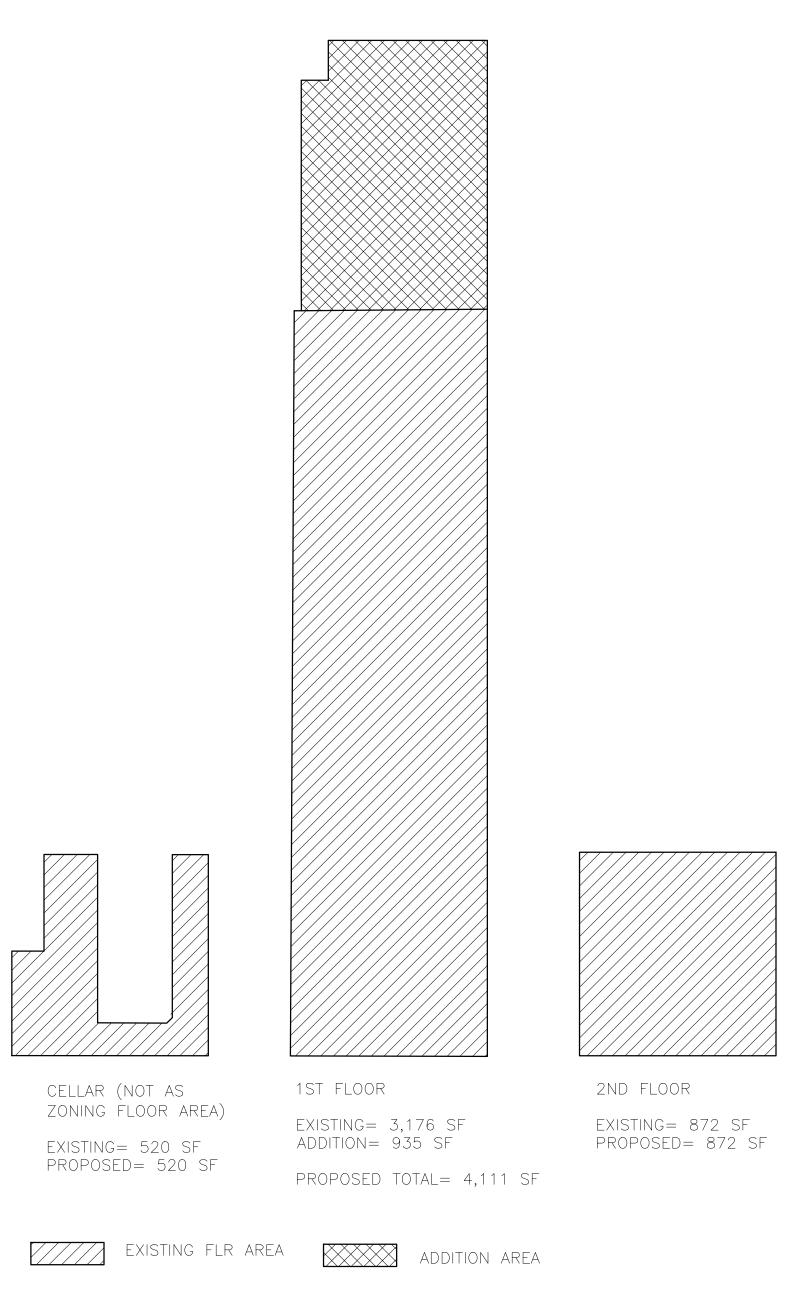

CALCULATION OF FLOOR SURFACE AREA: TOTAL GROSS FLOOR AREA = 520+4111+872 = 5503 SF TOTAL ZONING FLOOR AREA = 4111+872 = 4983 SF

CALCULATION OF INCREASE IN FLOOR SURFACE AREA: (PROPOSED - EXISTING TO REMAIN) / (EXISTING TO REMAIN) = 935 / 4568 = 20.5 % < 110% Thus this application is not required to meet new building requirement as per §28-101.4.5 & BUILDINGS BULLETIN 2016-012

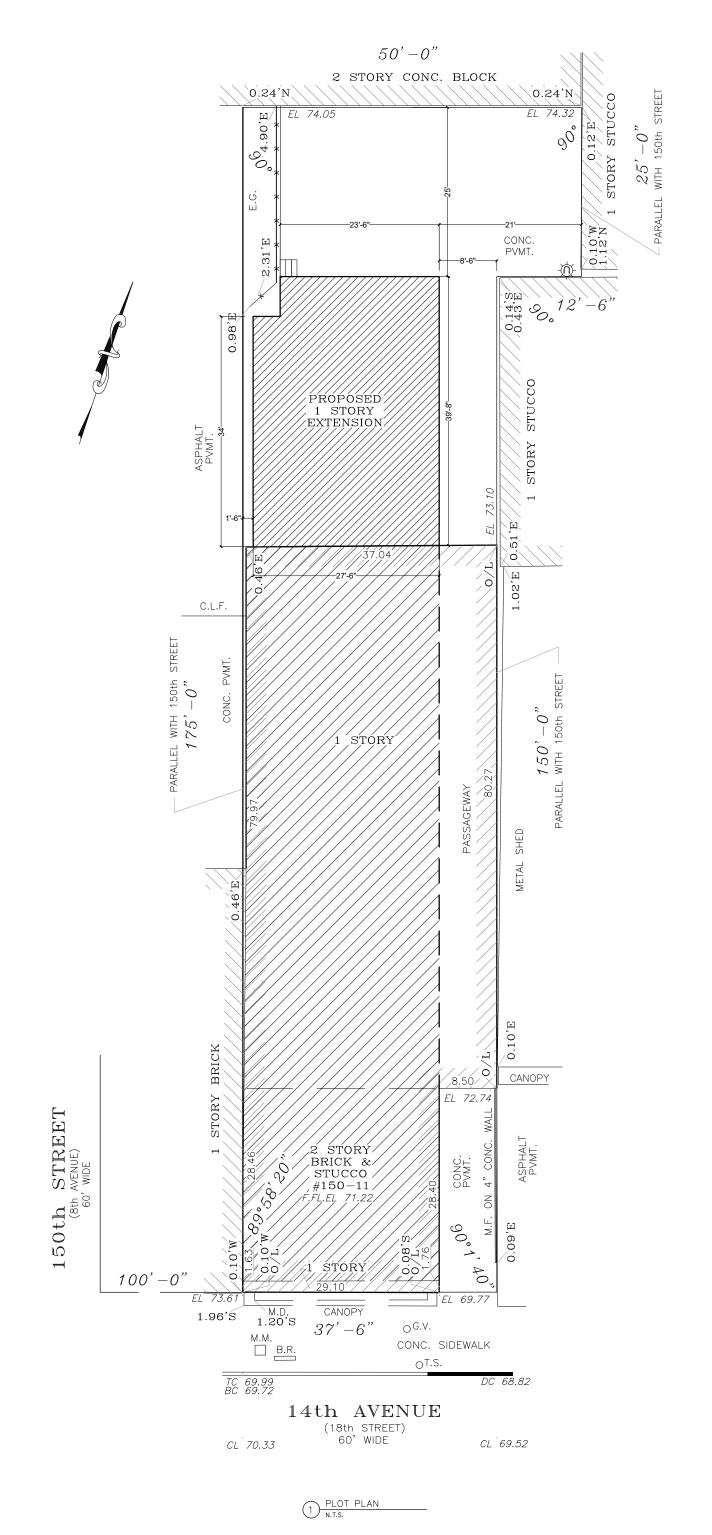



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PROJECT LOCATION:

150-11 14th Ave,Queens NY 11357

PROJECT NAME:

INTERIOR RENOVATION

NO.	REVISION	

B-SCAN:

NYC DOB STAMPS AND SIGNATURES:





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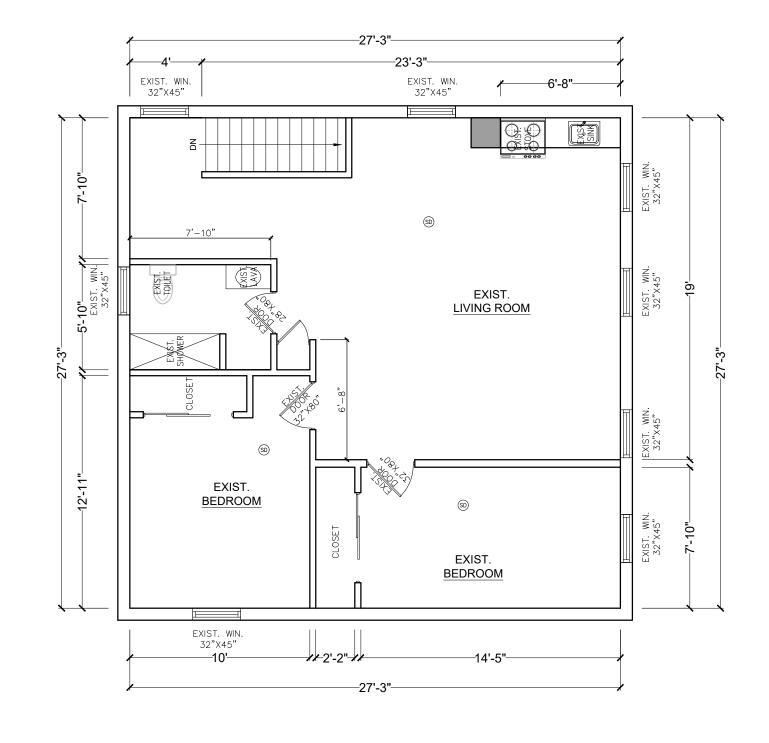
SITE PLAN, ZONING ANALYSIS

Q00886404-I1

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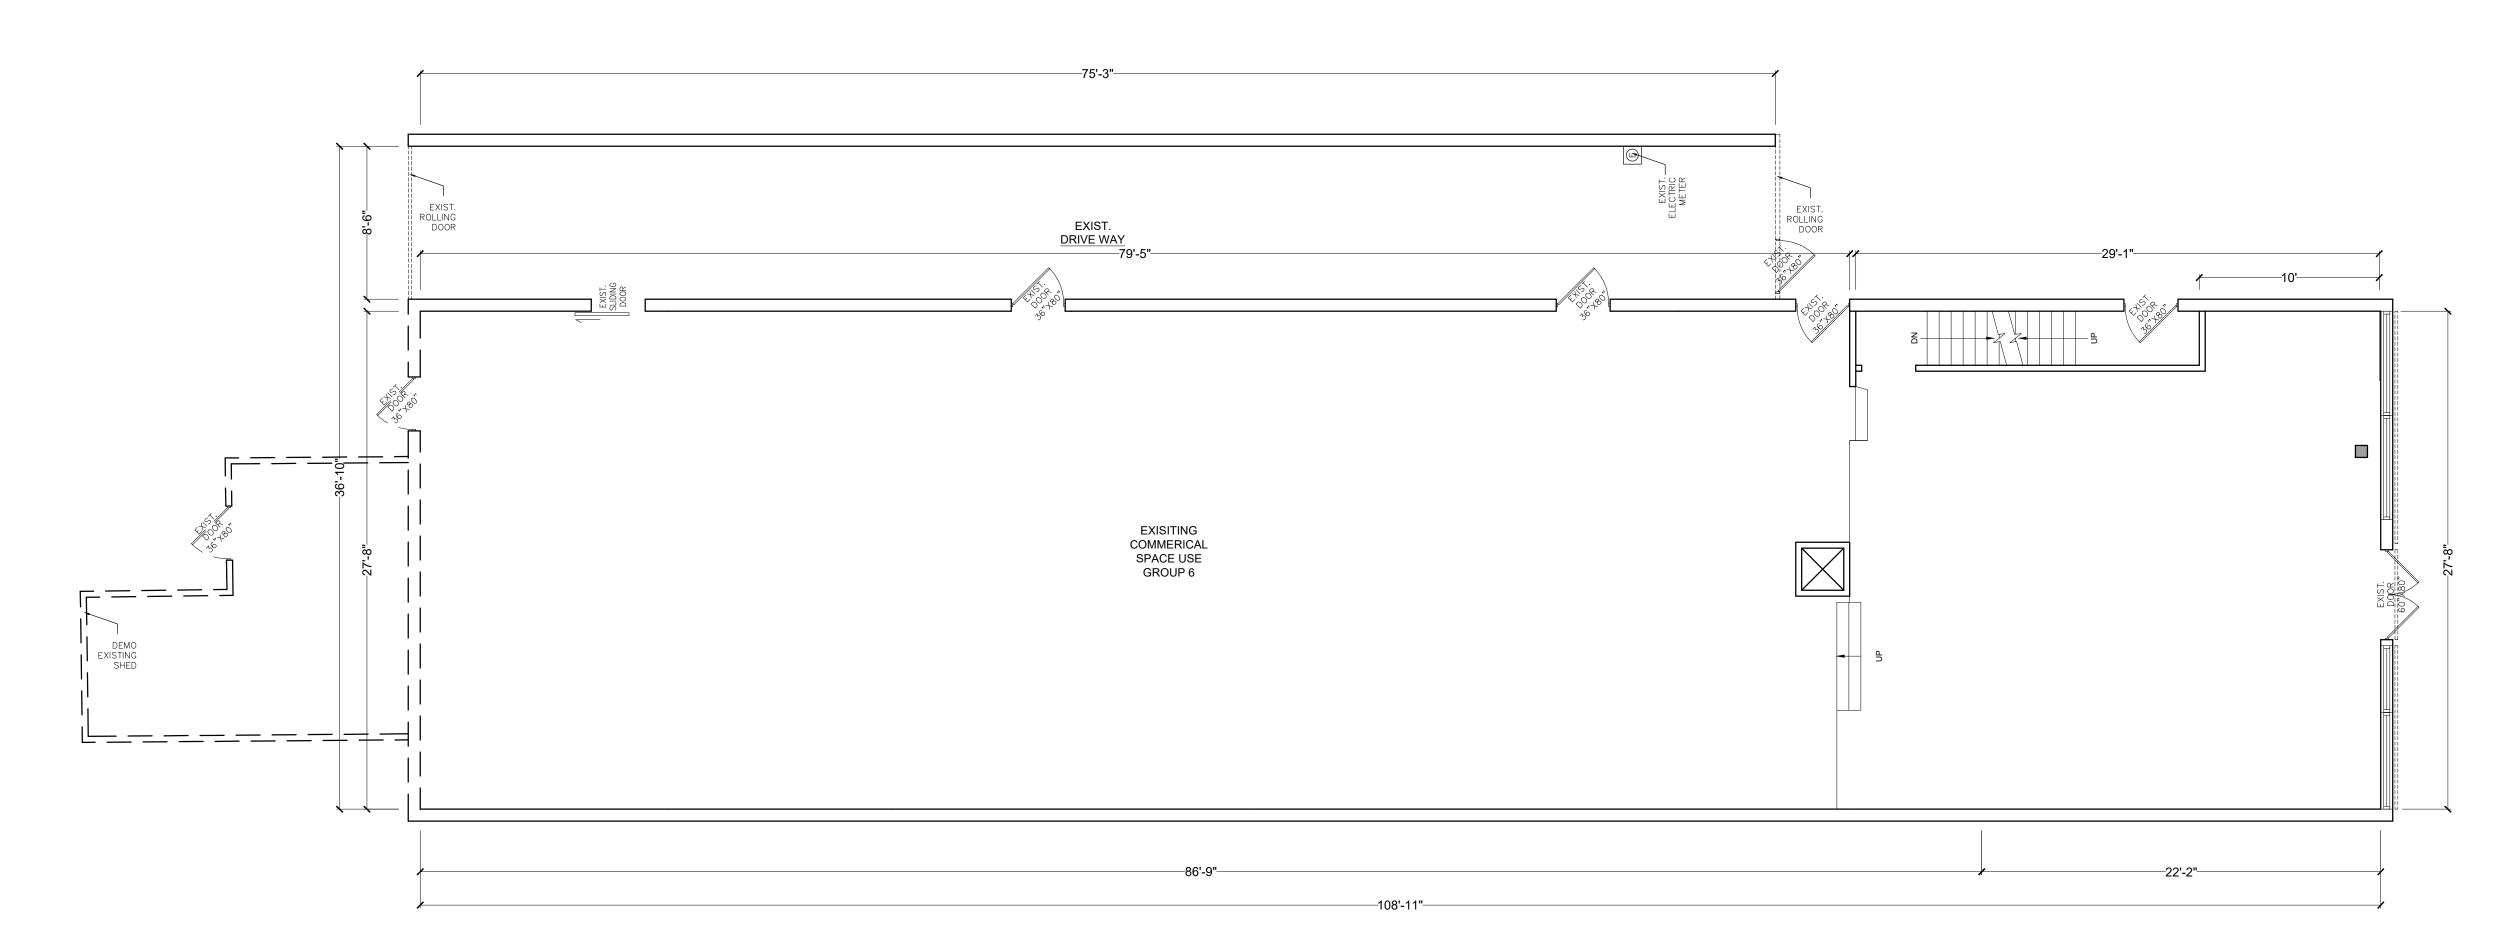





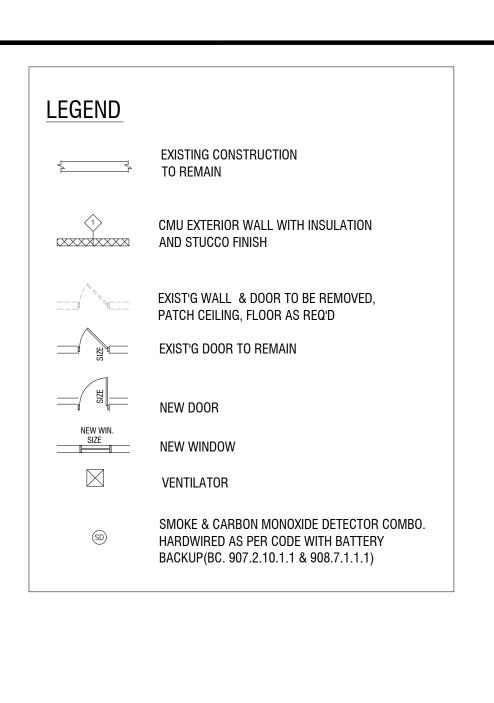

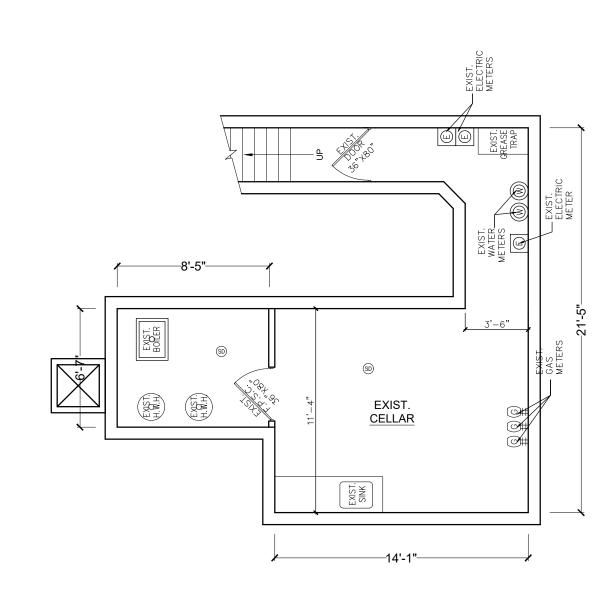SCALE: 3/16" = 1'-0"

2 EXISTING 2ND FL.PLAN SCALE: 3/16" = 1'-0"



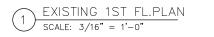



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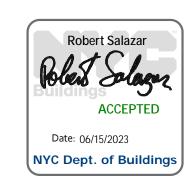
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INTERIOR RENOVATION

NO.	REVISION	

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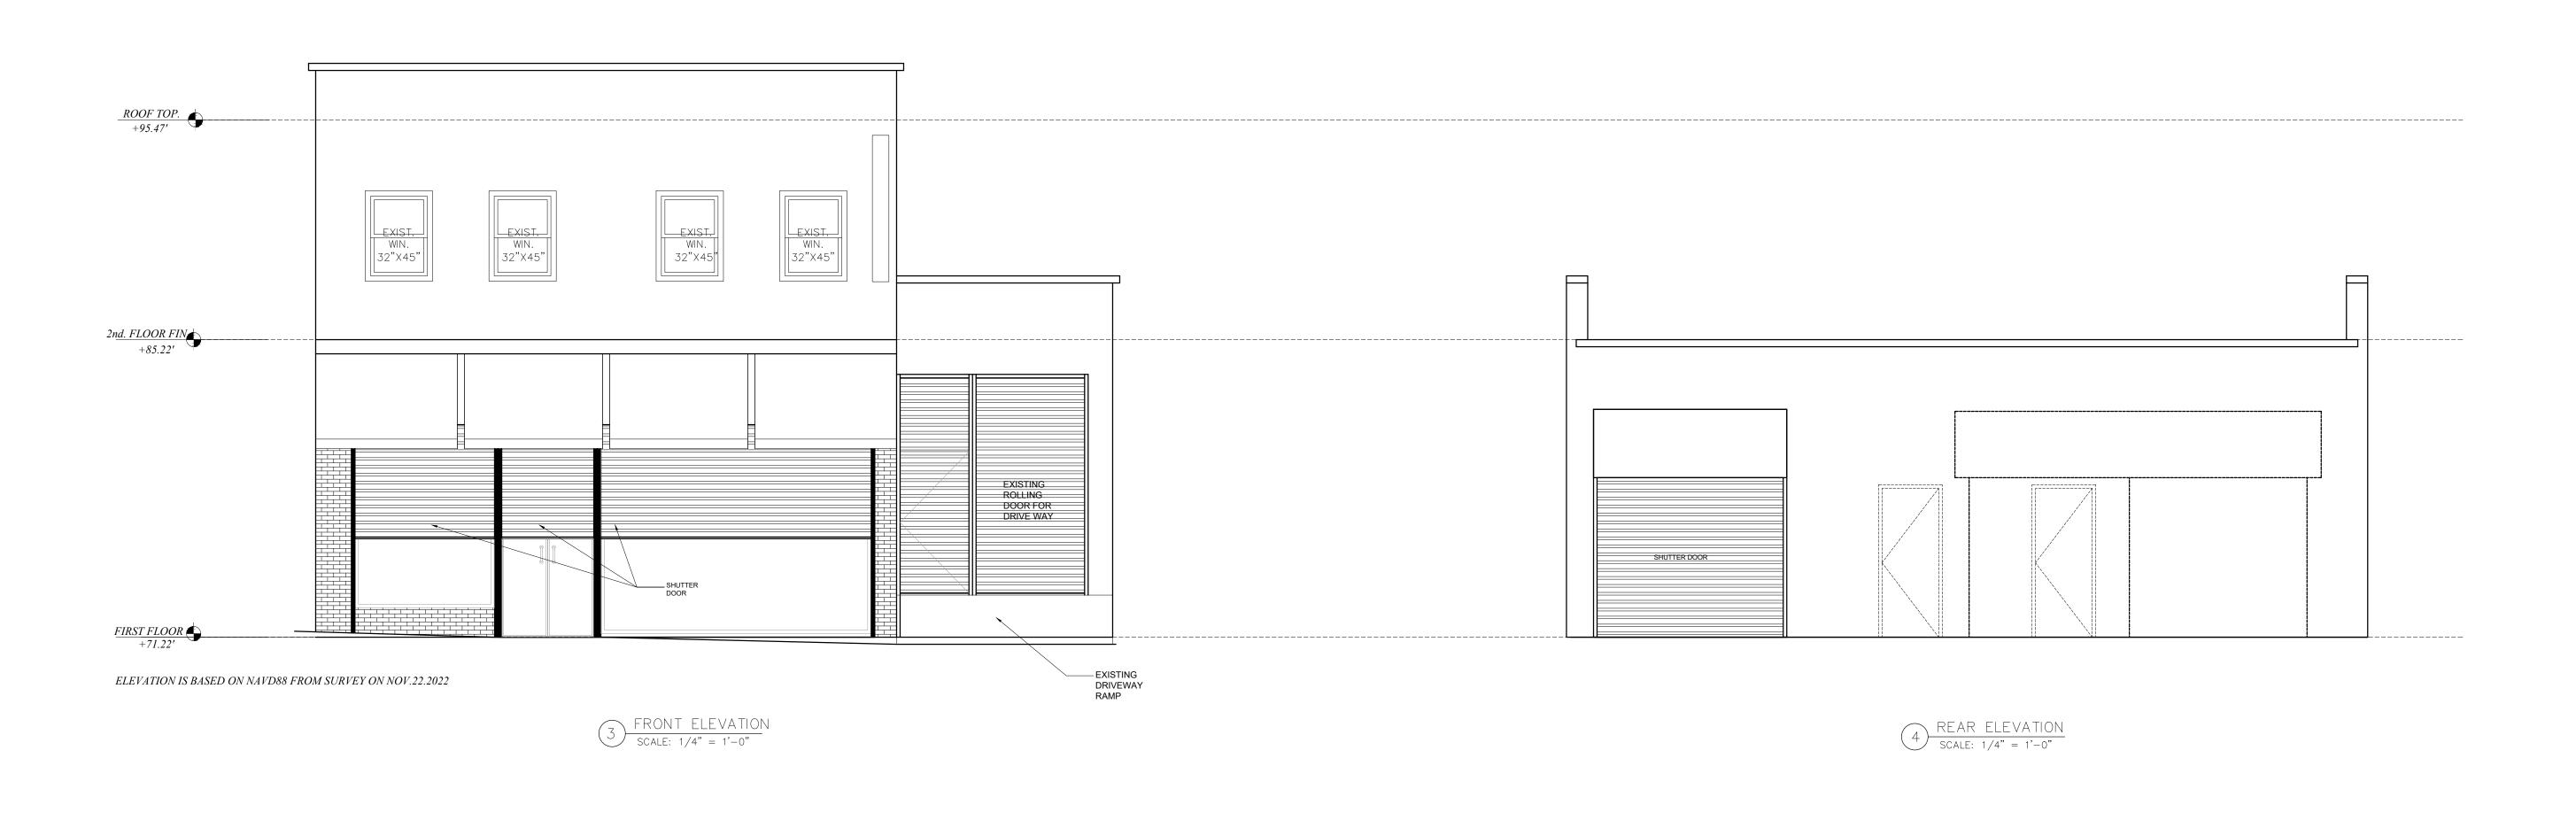
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PARTIAL DEMO. PLANS

Q00886404-I1



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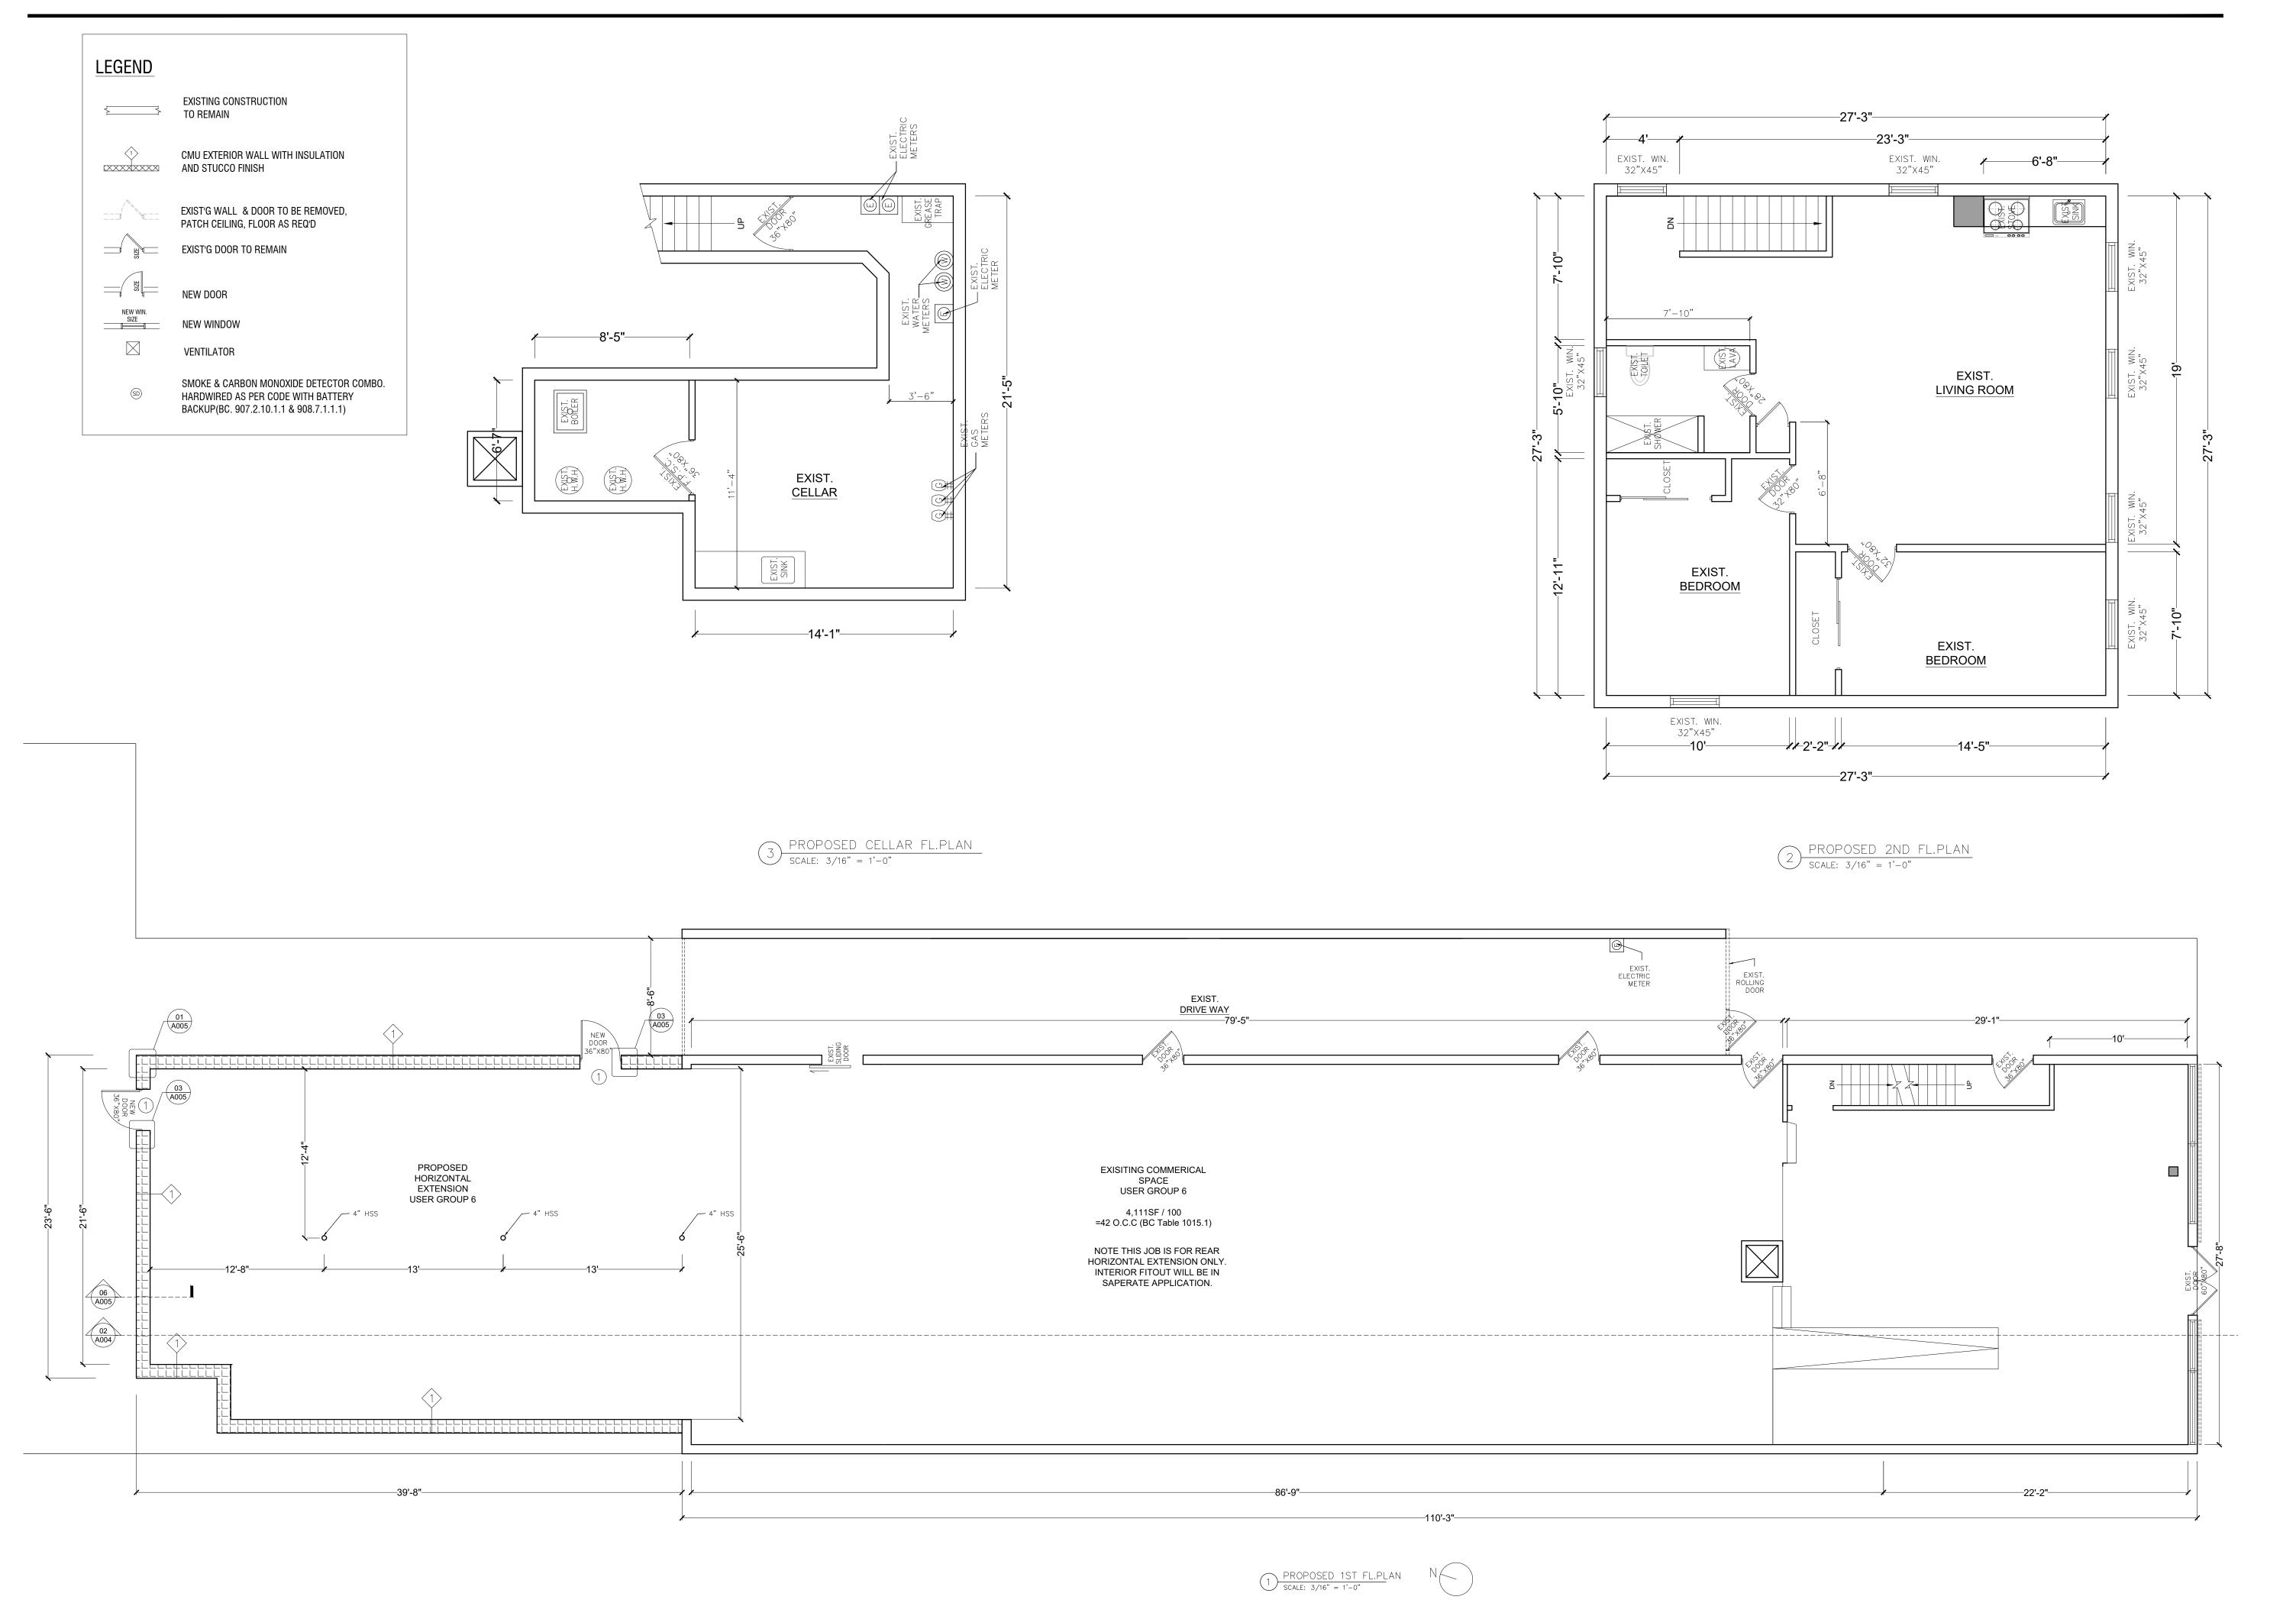
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EXISTING ELEVATIONS

Q00886404-I1

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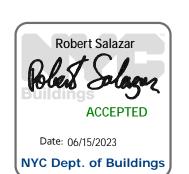
PROJECT NAME:

INTERIOR RENOVATION

NO. REVISION

B-SCAN:

NYC DOB STAMPS AND SIGNATURES:



DRAWING TITLE:

PROPOSED PLANS

Q00886404-I1

SEAL & SIGNATURE:

DATE: 11-22-2022

PROJECT NO.: 22.0

DRAWN BY: ZX

CHECK BY: ZX

DATE: 11-22-2022

PROJECT NO.: 22.022


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SHEET NO.:

A-001.00





PROPOSED REAR ELEVATION

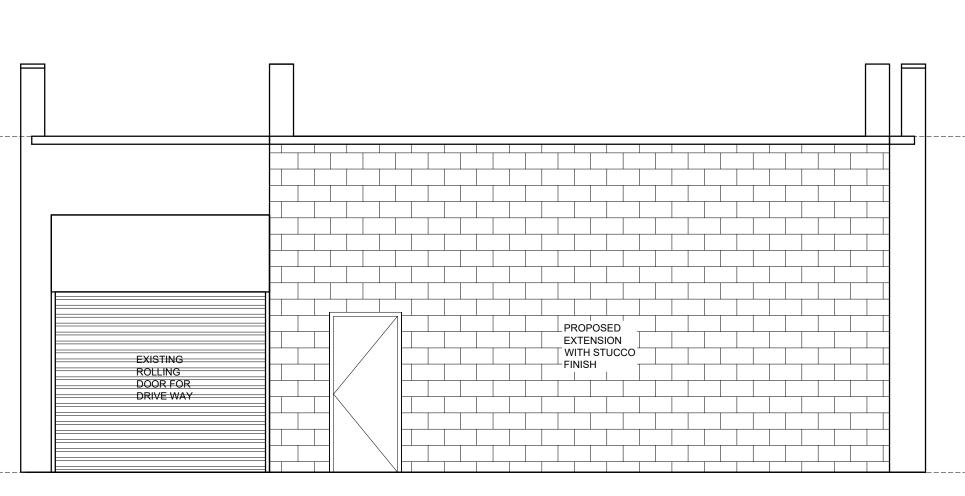SCALE: 1/4" = 1'-0"



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INTERIOR RENOVATION

NO.	REVISION	

B-SCAN:

NYC DOB STAMPS AND SIGNATURES:




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PROPOSED ELEVATIONS

Q00886404-I1

SEAL & SIGNATURE: DATE: 11-22-2022 PROJECT NO.:22.022 DRAWN BY:ZX CHECK BY: ZX

DASTING SOUTHOOR UNIT

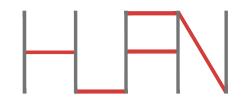

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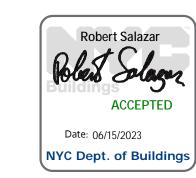
PROJECT NAME:

INTERIOR RENOVATION

NO.	REVISION	
-		

B-SCA

NYC DOB STAMPS AND SIGNATURES:



DRAWING TITLE:

ROOF PLAN

Q00886404-I1

SEAL & SIGNATURE:

DATE: 11-22-2022

PROJECT NO.:22.02

DRAWN BY:ZX

CHECK BY: ZY

DATE: 11-22-2022


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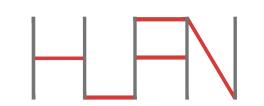
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SHEET NO.:

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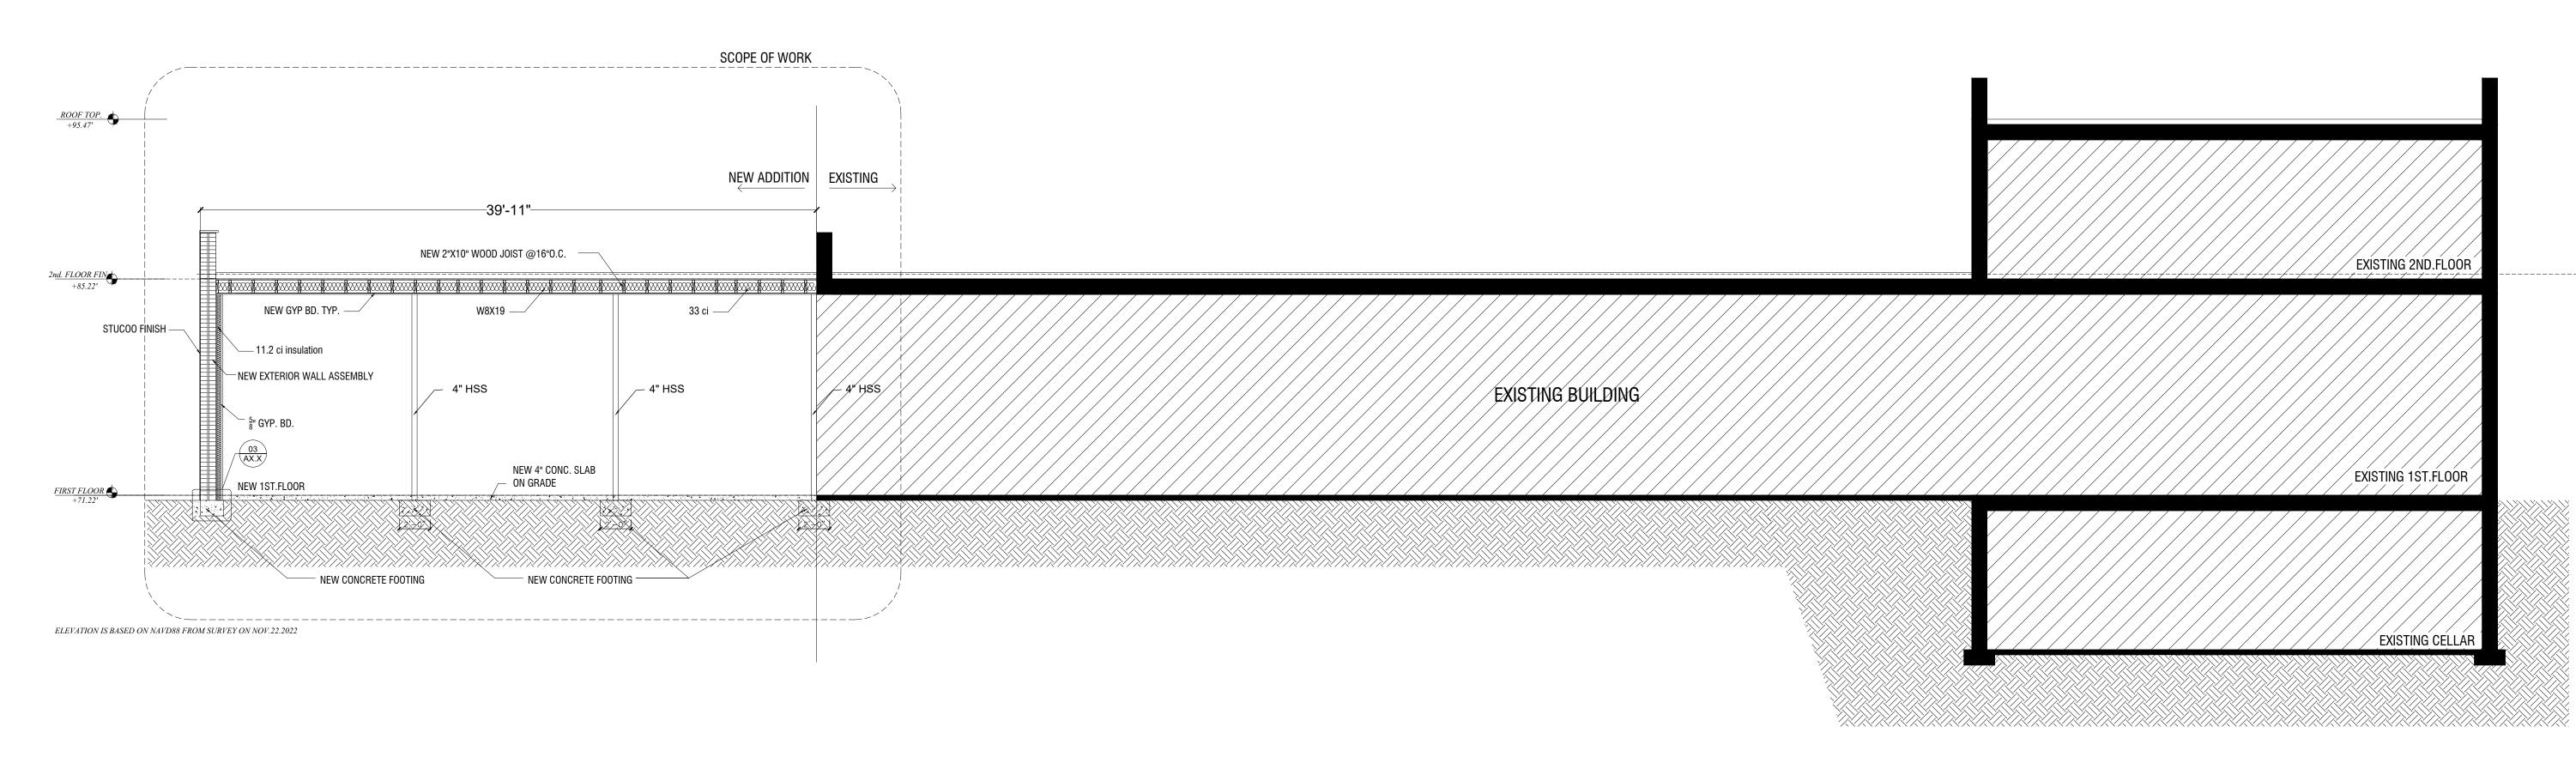
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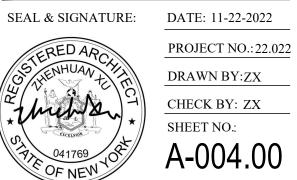



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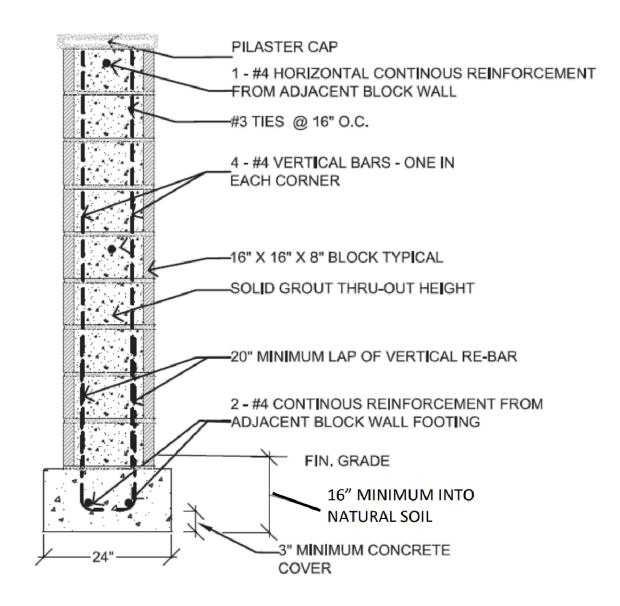
SECTIONS AND FRAMING PLAN


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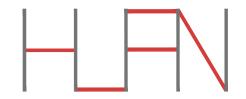
CHECK BY: ZX



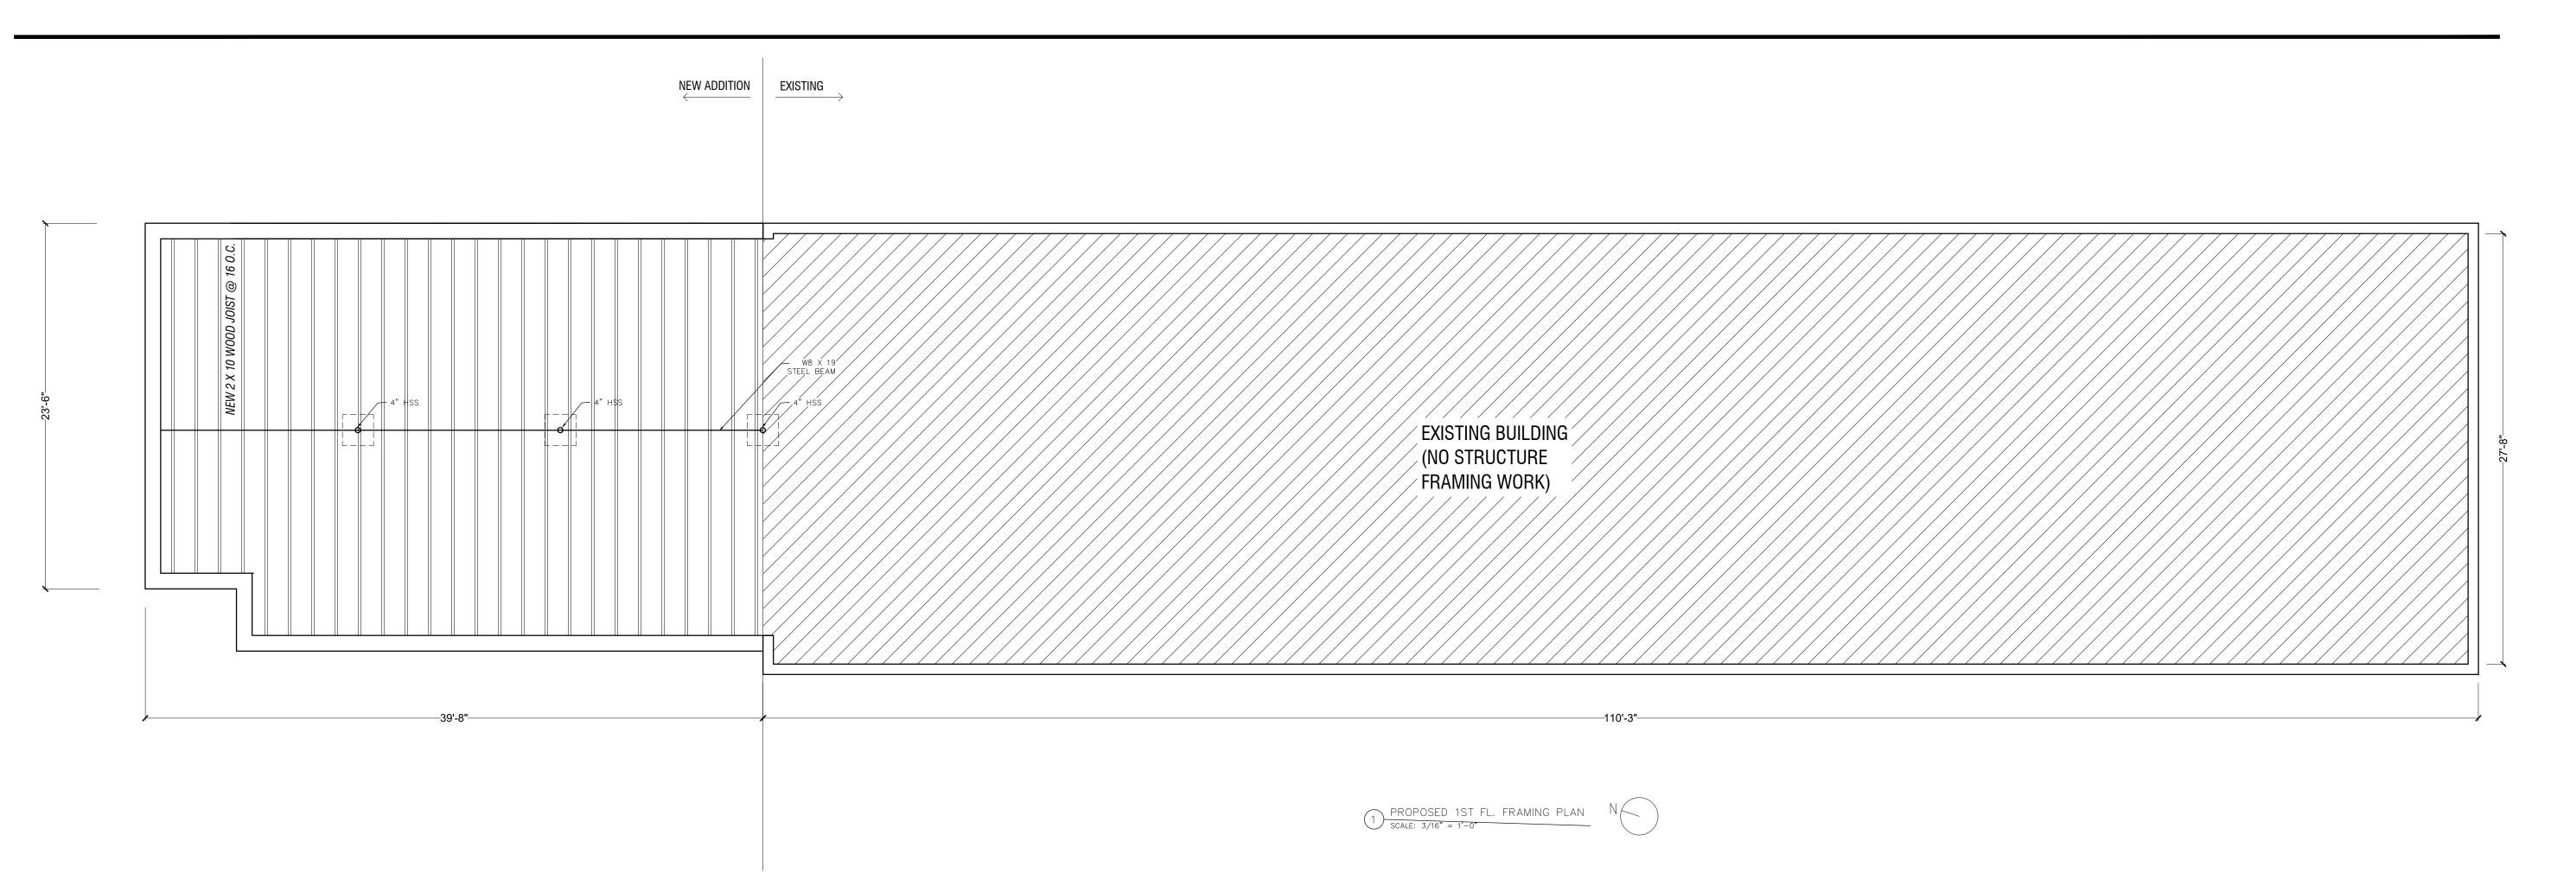



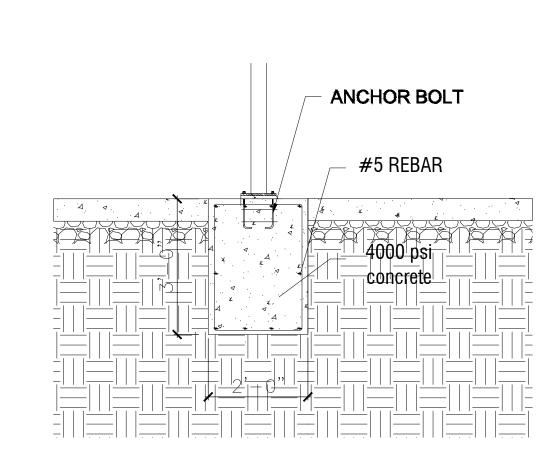

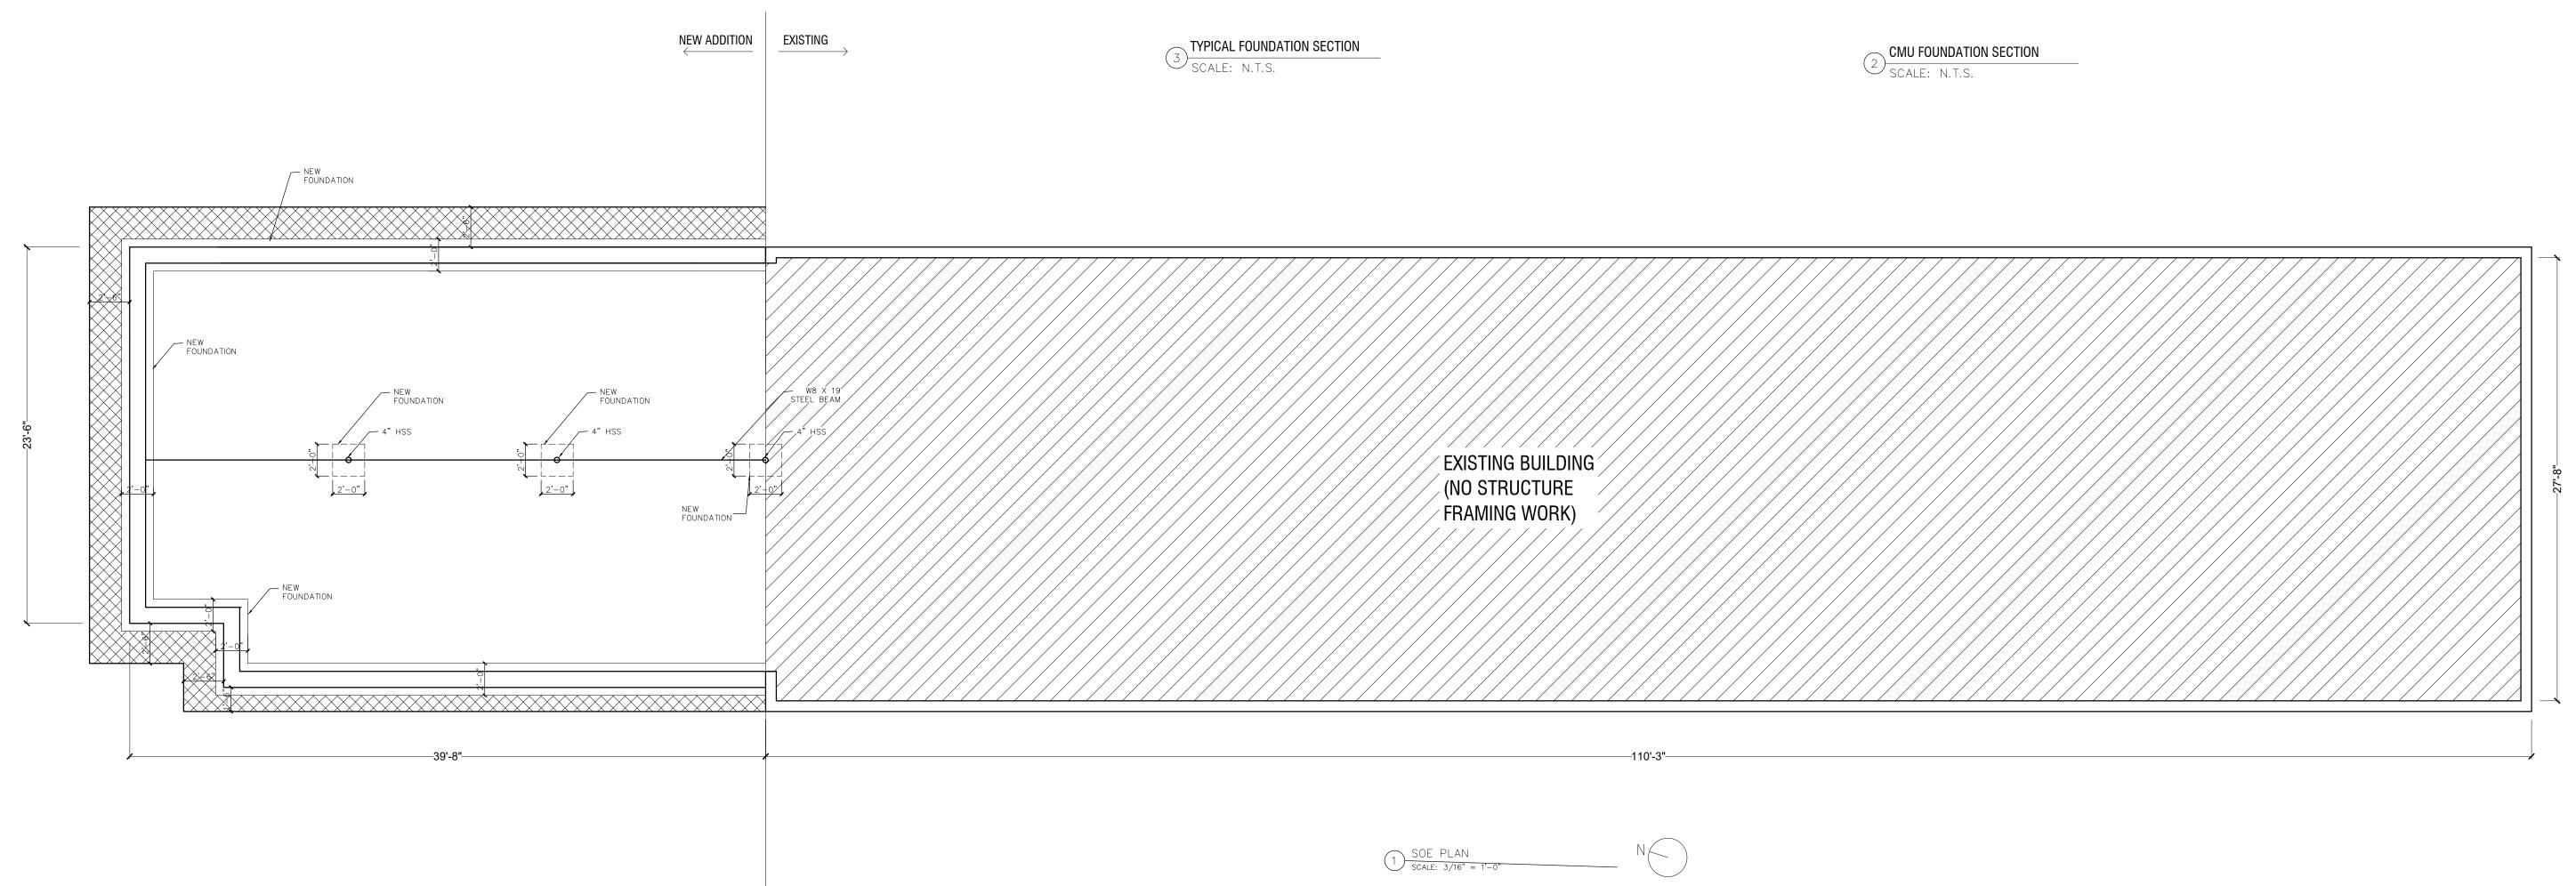

136-20 38TH AVE #11A, FLUSHING, NY, 11354 TEL: 646.797.6980 EMAIL:huanarchitect@gmail.com

PROJECT LOCATION:

150-11 14th Ave,Queens NY 11357

PROJECT NAME:

INTERIOR RENOVATION

	NO.	REVISION	_
_			
_			
_			

B-SCAN:

NYC DOB STAMPS AND SIGNATURES:




DRAWING TITLE:


EXAVATION AND FOUNDATION

Q00886404-I1

SEAL & SIGNATURE: DATE: 11-22-2022 PROJECT NO.:22.022 DRAWN BY:ZX CHECK BY: ZX SHEET NO.:

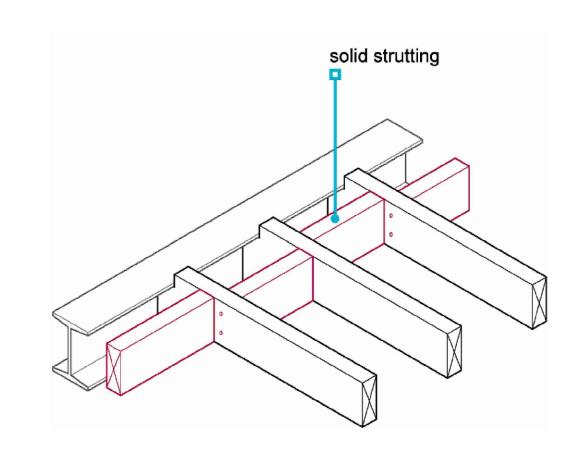

7 WOOD JOIST WITH I BEAM DETAIL SCALE: N.T.S.

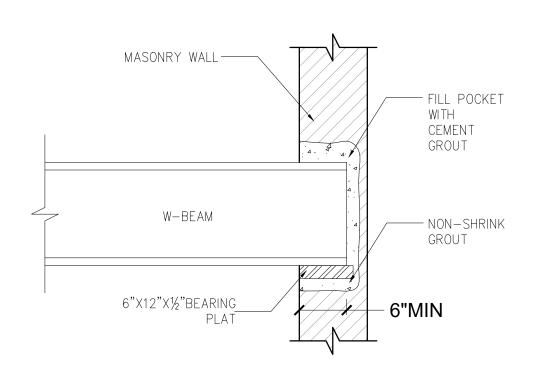

LINTEL SCHEDULE


OPNG. WIDTH (MAX)FT.	10 & 12 IN. WALL
2	$2-L3\frac{1}{2}X3\frac{1}{2}X\frac{1}{4}$
4	$2-L3\frac{1}{2}X3\frac{1}{2}X\frac{1}{4}$
5	$2-L3\frac{1}{2}X3\frac{1}{2}X\frac{1}{4}$
6	$2-L4\times3\frac{1}{2}\times\frac{1}{4}$
7	$2-L5 \times 3\frac{1}{2} \times \frac{5}{16}$
8	$2-L5X3\frac{1}{2}X\frac{5}{16}$


LINTEL AT 8",10"


& 12" WALL


NOTE: FIRE PROOF LINTEL W/MTL LATH & 2"CEMENT PLASTER



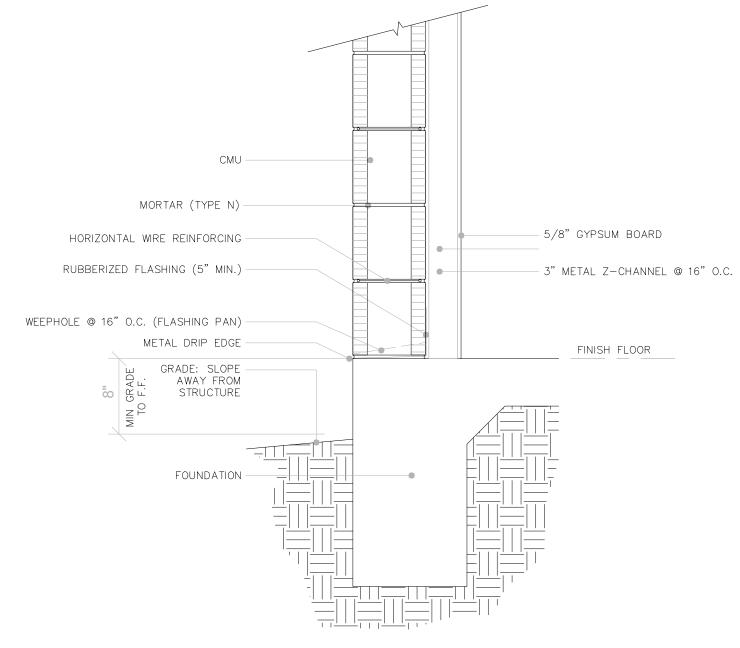


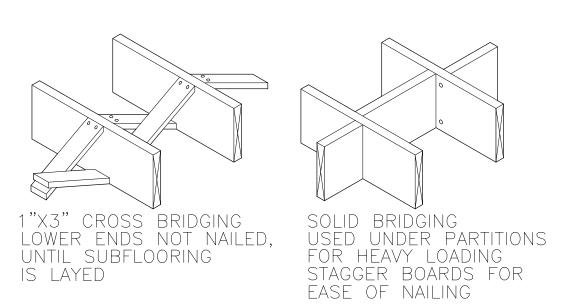

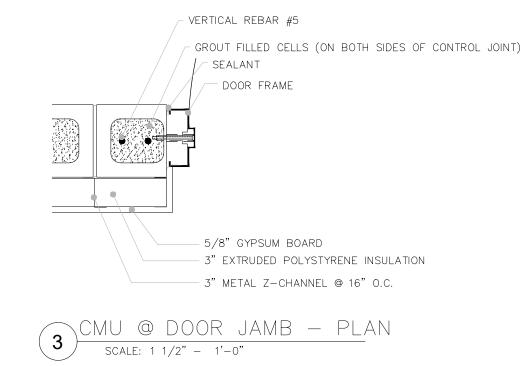

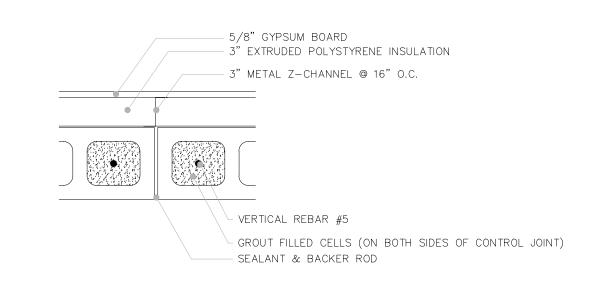

5 CMU ELEVATION
N.T.S.

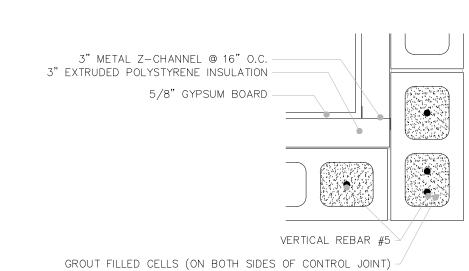

VERTICAL BARS AT OPENING JAMBS TO

BE FULL HEIGHT AND TIE INTO TOP BEAM.





HUAN DESIGN INC.

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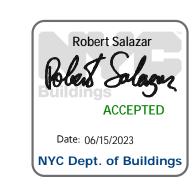
PROJECT NAME:

INTERIOR RENOVATION

REVISION

B-SCAN:


NYC DOB STAMPS AND SIGNATURES:





DRAWING TITLE:

DETAILS

Q00886404-I1

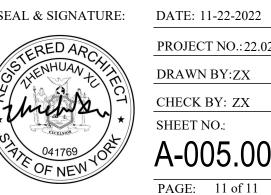

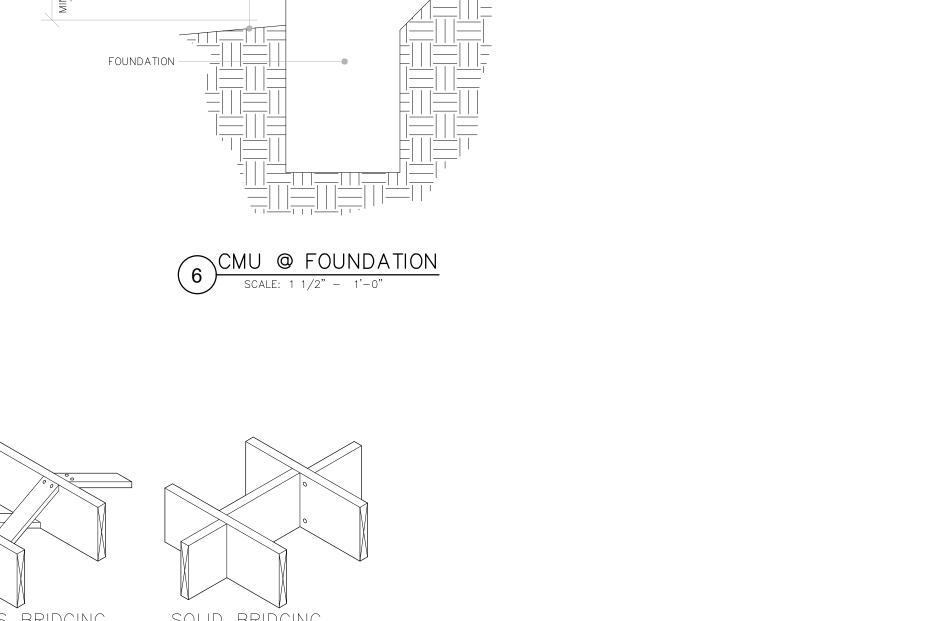

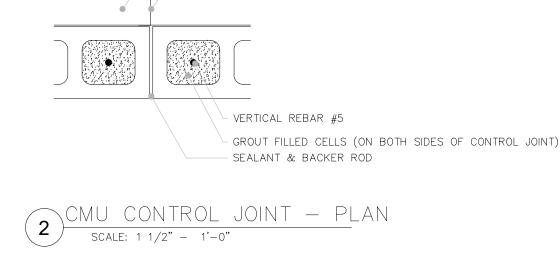



8" BOND BEAM W/ #5 CONT.—

WHERE HORIZONTAL REINFORCING STOPS AT OPENING OR CONTROL JOINT, PROVIDE STANDARD HOOK INTO VERTICAL WALL REINFORCING

